

EXHIBIT E

22-2023	SCALE: NONE
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WEATHER KING
P.O. BOX 108
PARIS, TN 38242

A circular professional engineer seal for Kevin L. Nolan, State of Florida, License No. 77209. The seal features the text "KEVIN L. NOLAN" at the top, "LICENSE" below it, "No. 77209" in the center, and "STATE OF FLORIDA" below the center. The outer ring of the seal contains the text "PROFESSIONAL ENGINEER". There are three stars: one on the left, one on the right, and one below the center text.

Weather King
PORTABLE BUILDINGS

SHEET NUMBER

S-O-LB

SCALE: NONE

1. This item has been electronically signed and sealed by Kevin L Nolan, PE on 03/22/2023 using a digital signature.
2. Printed copies of this document are not considered signed and sealed and the signature must be verified on any electronic copy.

Approved by Phillip E Robbins
Florida PE-49070
Plan No. 1RPER210076 Date: 03/27/2023

FASTENING SCHEDULE

ND
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DOCUMENT

DESCRIPTION OF BUILDING ELEMENT	NUMBER AND TYPE OF FASTENER	SPACING AND LOCATION
ROOF FRAMING		
1. BLOCKING BETWEEN CEILING JOISTS OR RAFTERS TO TOP PLATE OR OTHER FRAMING.	3 - 8d COMMON (2 1/2" x 0.131") 3 - 10d BOX (3" x 0.128") 3 - 3" x 0.131" NAILS 3 - 3" 14 GAGE STAPLES, 1/16" CROWN	EACH END, TOENAIL
2. BLOCKING BETWEEN RAFTERS NOT AT THE WALL TOP PLATE, TO RAFTER.	2 - 8d COMMON (2 1/2" x 0.131") 2 - 3" x 0.131" NAILS 2 - 3" 14 GAGE STAPLES 2 - 16d COMMON (3 1/2" x 0.162") 3 - 3" x 0.131" NAILS 3 - 3" 14 GAGE STAPLES	EACH END, TOENAIL END NAIL
COLLAR TIE TO RAFTER	REFERENCE SHEETS S-2.4 AND S-2.5	
RAFTER OR ROOF TRUSS TO TOP PLATE	3 - 10d COMMON (3" x 0.148") 3 - 16d BOX (3 1/2" x 0.135") 4 - 10d BOX (3" x 0.128") 4 - 3" x 0.131" NAILS 4 - 3" 14 GAGE STAPLES, 1/16" CROWN	TOENAIL ^b
CEILING JOISTS TO TOP PLATE	3 - 8d COMMON (2 1/2" x 0.131") 3 - 10d BOX (3" x 0.128") 3 - 3" x 0.131" NAILS 3 - 3" 14 GAGE STAPLES, 1/16" CROWN	EACH JOIST, TOENAIL
WALL FRAMING		
STUD TO STUD (NOT AT BRACED WALL PANELS)	16d COMMON (3 1/2" x 0.162")	24" O.C. FACE NAIL
	10d BOX (3" x 0.128") 3" x 0.131" NAILS 3 - 3" 14 GAGE STAPLES	16" O.C. FACE NAIL
	16d COMMON (3 1/2" x 0.162")	16" O.C. FACE NAIL
STUD TO STUD AND ABUTTING STUDS AT INTERSECTING WALL CORNERS (AT BRACED WALL PANELS)	16d BOX (3 1/2" x 0.135")	12" O.C. FACE NAIL
	3" x 0.131" NAILS	12" O.C. FACE NAIL
	3 - 3" 14 GAGE STAPLES, 1/16" CROWN	12" O.C. FACE NAIL
CONTINUOUS HEADER TO STUD	4 - 8d COMMON (2 1/2" x 0.131") 4 - 10d BOX (3" x 0.128")	TOENAIL
TOP PLATE TO TOP PLATE	16d COMMON (3 1/2" x 0.162")	16" O.C. FACE NAIL
	10d BOX (3" x 0.128") 3" x 0.131" NAILS	12" O.C. FACE NAIL
	3" 14 GAGE STAPLES, 1/16" CROWN	

DESCRIPTION OF BUILDING ELEMENT	NUMBER AND TYPE OF FASTENER	SPACING AND LOCATION
WALL FRAMING (CONT.)		
TOP PLATE TO TOP PLATE, AT END JOINTS	8 - 16d COMMON (3 1/2" x 0.162") 12 - 10d BOX (3" x 0.128") 12 - 3" x 0.131" NAILS 12 - 3" 14 GAGE STAPLES, 1/16" CROWN	EACH SIDE OF END JOINT, FACE NAIL (MINIMUM 24" LAP SPLICE LENGTH EACH SIDE OF END JOINT)
BOTTOM PLATE TO JOIST, RIM JOIST, BAND JOIST, OR BLOCKING (NOT AT BRACED WALL PANELS)	16d COMMON (3 1/2" x 0.162") 16d BOX (3 1/2" x 0.135") 3" x 0.131" NAILS 3" 14 GAGE STAPLES, 1/16" CROWN	16" O.C. FACE NAIL 12" O.C. FACE NAIL
BOTTOM PLATE TO JOIST, RIM JOIST, BAND JOIST, OR BLOCKING (AT BRACED WALL PANELS)	2 - 16d COMMON (3 1/2" x 0.162") 3 - 16d BOX (3 1/2" x 0.135") 4 - 3" x 0.131" NAILS 4 - 3" 14 GAGE STAPLES, 1/16" CROWN	16" O.C. FACE NAIL
STUD TO TOP OR BOTTOM PLATE	4 - 8d COMMON (2 1/2" x 0.131") 4 - 10d BOX (3" x 0.128") 4 - 3" x 0.131" NAILS 4 - 3" 14 GAGE STAPLES, 1/16" CROWN	TOENAIL
	2 - 16d COMMON (3 1/2" x 0.162") 3 - 10d BOX (3" x 0.128") 3 - 3" x 0.131" NAILS 3 - 3" 14 GAGE STAPLES, 1/16" CROWN	END NAIL
	2 - 16d COMMON (3 1/2" x 0.162") 3 - 10d BOX (3" x 0.128") 3 - 3" x 0.131" NAILS 3 - 3" 14 GAGE STAPLES, 1/16" CROWN	FACE NAIL
FLOOR FRAMING		
JOIST TO SKID	3 - 8d COMMON (2 1/2" x 0.131") 3 - 10d BOX (3" x 0.128") 3 - 3" x 0.131" NAILS 3 - 3" 14 GAGE STAPLES, 1/16" CROWN	TOENAIL
BUILT-UP BEAMS	10d BOX (3" x 0.128") 3" x 0.131" NAILS 3" 14 GAGE STAPLES, 1/16" CROWN	24" O.C. FACE NAIL AT TOP AND BOTTOM STAGGERED ON OPPOSITE SIDES
	AND: 3 - 10d BOX (3" x 0.128") 3 - 3" x 0.131" NAILS 3 - 3" 14 GAGE STAPLES, 1/16" CROWN	ENDS AND AT EACH SPLICE, FACE NAIL
	3 - 16d COMMON (3 1/2" x 0.162") 4 - 10d BOX (3" x 0.128") 4 - 3" x 0.131" NAILS 4 - 3" 14 GAGE STAPLES, 1/16" CROWN	END NAIL



LOFTED BARN--FLORIDA--WIND=160 MPH--FBC 2020

Kevin L. Nolan

Digitally signed by Kevin Nolan
DN:
0.9.2342.19200300.100.1.1=A01410C0000
0179D834EF80000196AF, cn=Kevin
Nolan, c=US
Date: 2023.03.22 13:44:53 -05'00'

Weather King
PORTABLE BUILDINGS

PROJECT NO:

DATE: 09-28-2021

DRAWN BY: KLN

CHECKED BY: KLN

REVISION:

SHEET NUMBER

S-0.1-LB

SCALE: NONE

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FASTENING SCHEDULE (CONT.)

DESCRIPTION OF BUILDING ELEMENT		NUMBER AND TYPE OF FASTENER	SPACING AND LOCATION	
SUBFLOOR, ROOF AND INTERIOR WALL SHEATHING ^a				
			EDGES (INCHES)	INTERMEDIATE SUPPORTS (INCHES)
⅛" TO ½"	6d COMMON OR DEFORMED (2" x 0.113") (SUBFLOOR AND WALL)	6	6	12
	8d COMMON OR DEFORMED (2½" x 0.131") (ROOF)	6	6	12
	2⅝" x 0.113" NAIL (SUBFLOOR AND WALL)	6	6	12
	1⅝" 16 GAGE STAPLE, ⅜" CROWN (SUBFLOOR AND WALL)	4	4	8
	2⅝" x 0.113" RING SHANK NAIL (ROOF)	6	6	12
	1⅝" 16 GAGE STAPLE, ⅜" CROWN (ROOF)	3	6	6
1½" TO ¾"	8d COMMON (2½" x 0.131") 6d DEFORMED (2" x 0.113") (SUBFLOOR AND WALL)	6	6	12
	2⅝" x 0.113" RING SHANK NAIL	6	6	12
EXTERIOR WALL SIDING				
⅜" LP SMARTSIDE PRECISION PANEL OR ⅝" TREATED T1-11 SIDING	2⅝" x 0.113" RING SHANK NAIL	6 (SIDE WALL)	6	6
	2⅝" x 0.113" RING SHANK NAIL	3 (END WALL)	6	6

a. NAILS SPACED AT 6 INCHES AT INTERMEDIATE SUPPORTS WHERE SPANS ARE 48 INCHES OR MORE. NAILS FOR WALL SHEATHING ARE PERMITTED TO BE COMMON, BOX, OR CASING.
b. WHERE A RAFTER IS FASTENED TO AN ADJACENT PARALLEL CEILING JOIST IN ACCORDANCE WITH THIS SCHEDULE AND THE CEILING JOIST IS FASTENED TO THE TOP PLATE IN ACCORDANCE WITH THIS SCHEDULE, THE NUMBER OF TOENAILS IN THE RAFTER SHALL BE PERMITTED TO BE REDUCED BY ONE NAIL.

Approved by Phillip E Robbins
Florida PE-49070
Phillip E Robbins
Plan No. 1RPER210076 Date: 03/27/2023

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LOFTED BARN--FLORIDA--WIND=160 MPH--FBC 2020

Kevin Nolan

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DN:
0.9.2342.19200300.100.1.1=A01410C000
00179D834EF80000196AF, cn=Kevin
Nolan, c=US
Date: 2023.03.22 13:45:13 -05'00'


Weather King®
PORTABLE BUILDINGS

PROJECT NO:
DATE: 09-28-2021
DRAWN BY: KLN
CHECKED BY: KLN
REVISION:

SHEET NUMBER
S-0.2-LB
SCALE: NONE

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Florida PE-49070
Phillip E Robbins
Plan No. 1RPER210076 Date: 03/27/2023

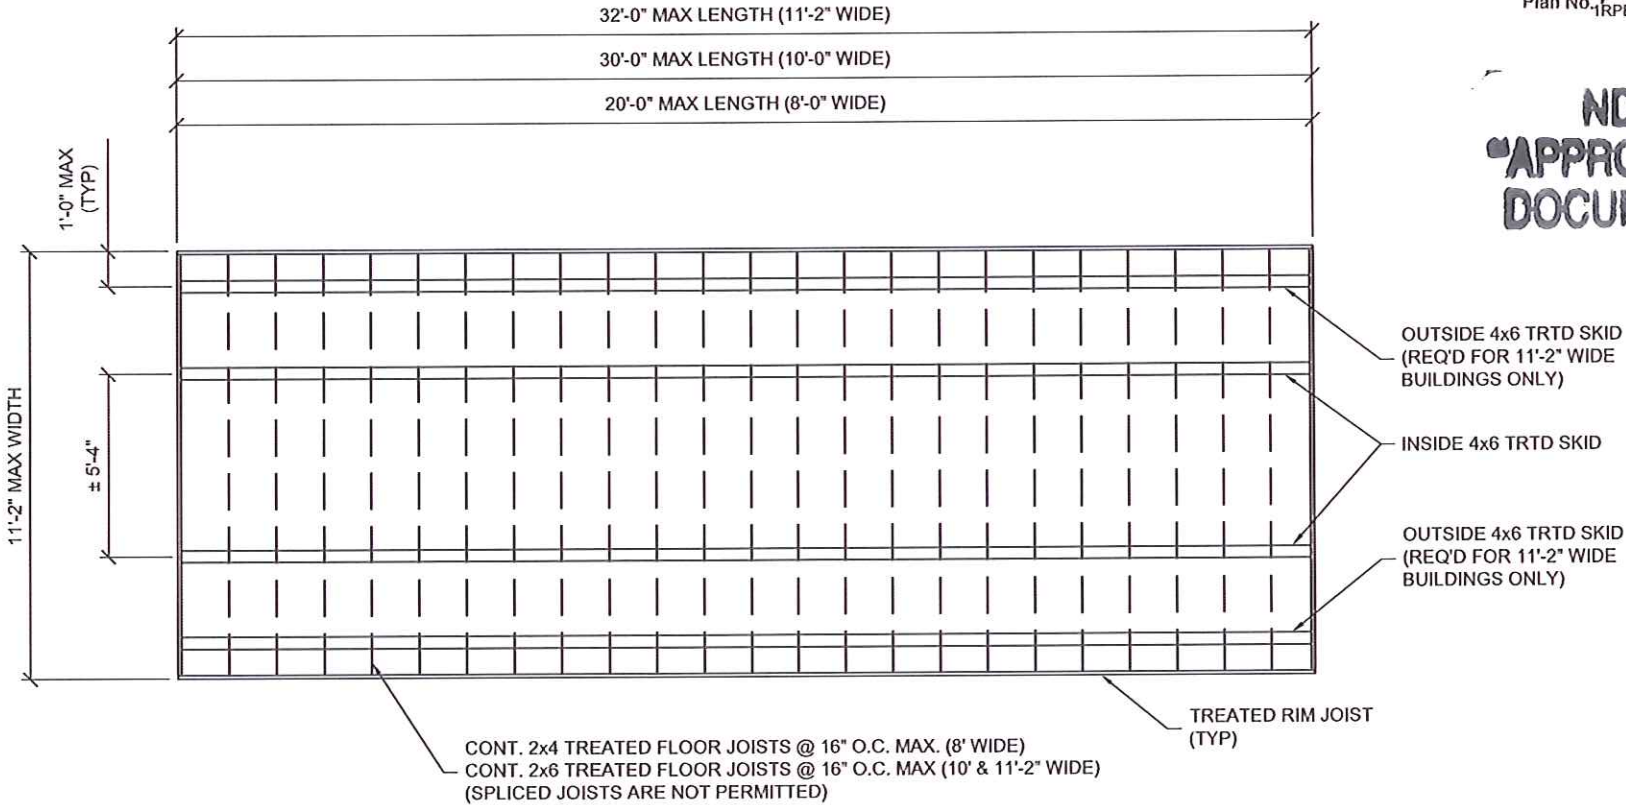

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TYPICAL FLOOR FRAMING PLAN



LOFTED BARN--FLORIDA--WIND=160 MPH--FBC 2020

Kevin Nolan

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DN:
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000179D834EF80000196AF, cn=Kevin
Nolan, c=US
Date: 2023.03.22 13:45:32 -05'00'

Weather King
PORTABLE BUILDINGS


PROJECT NO:	
DATE:	09-28-2021
DRAWN BY:	KLN
CHECKED BY:	KLN
REVISION:	

SHEET NUMBER
S-10-LB
SCALE: NOT TO SCALE

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Florida PE-49070
Phillip E Robbins
Plan No. 1RPER210076 Date: 03/27/2023

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LOFTED BARN CABIN FLOOR FRAMING PLAN (OPTIONAL)

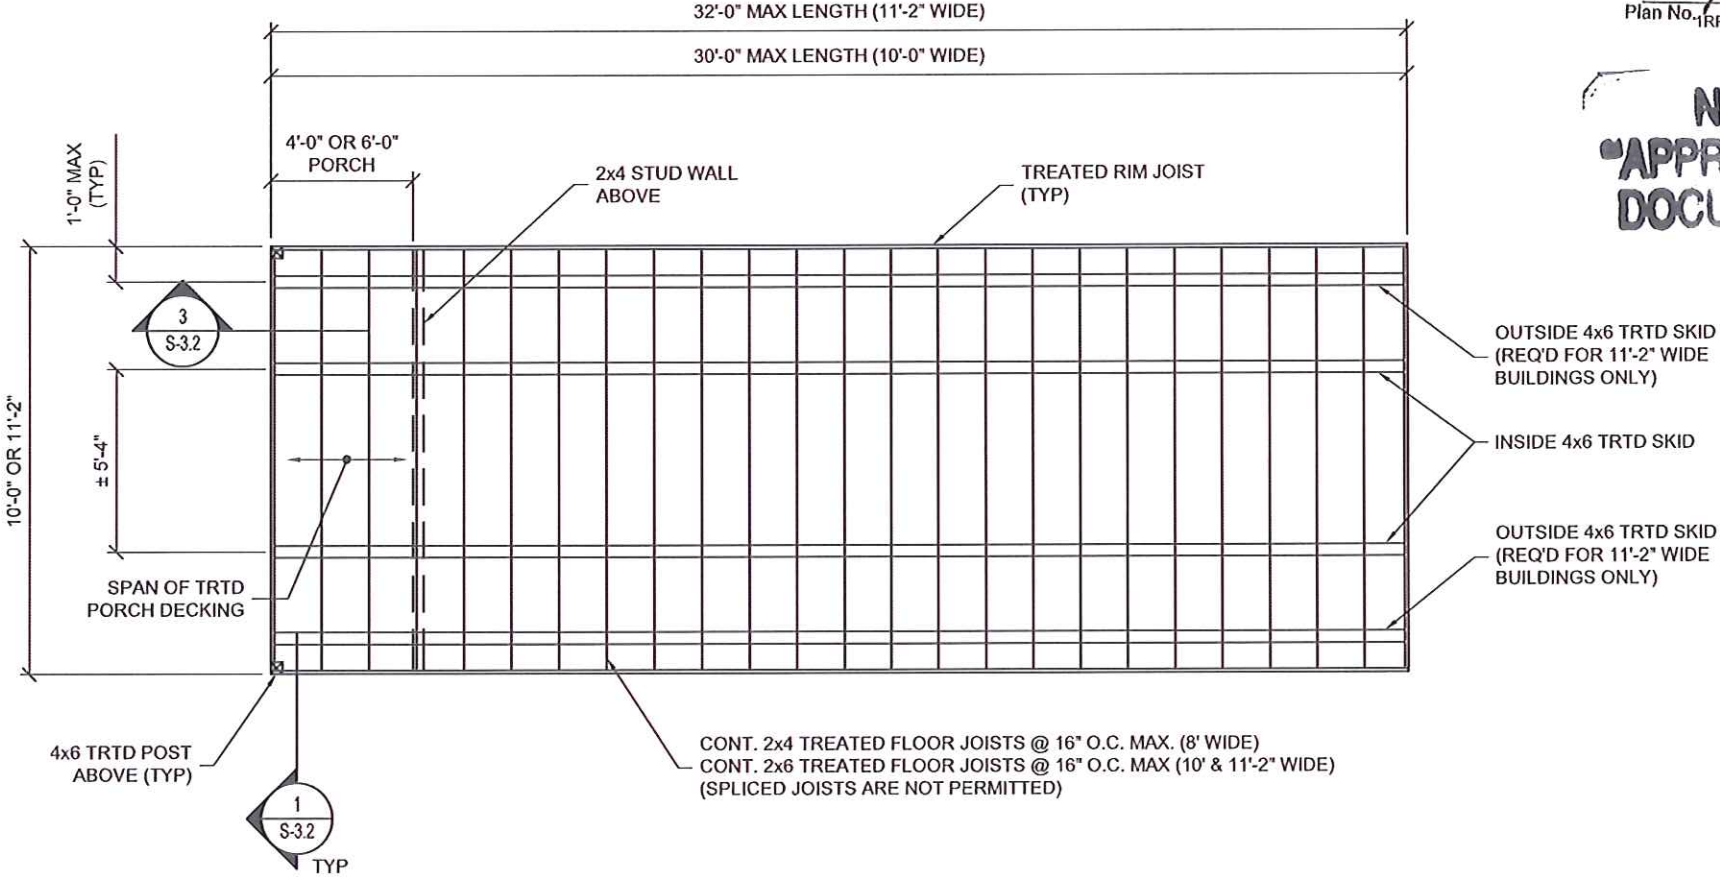

LOFTED BARN--FLORIDA--WIND=160 MPH--FBC 2020

Kevin L. Nolan

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c=US
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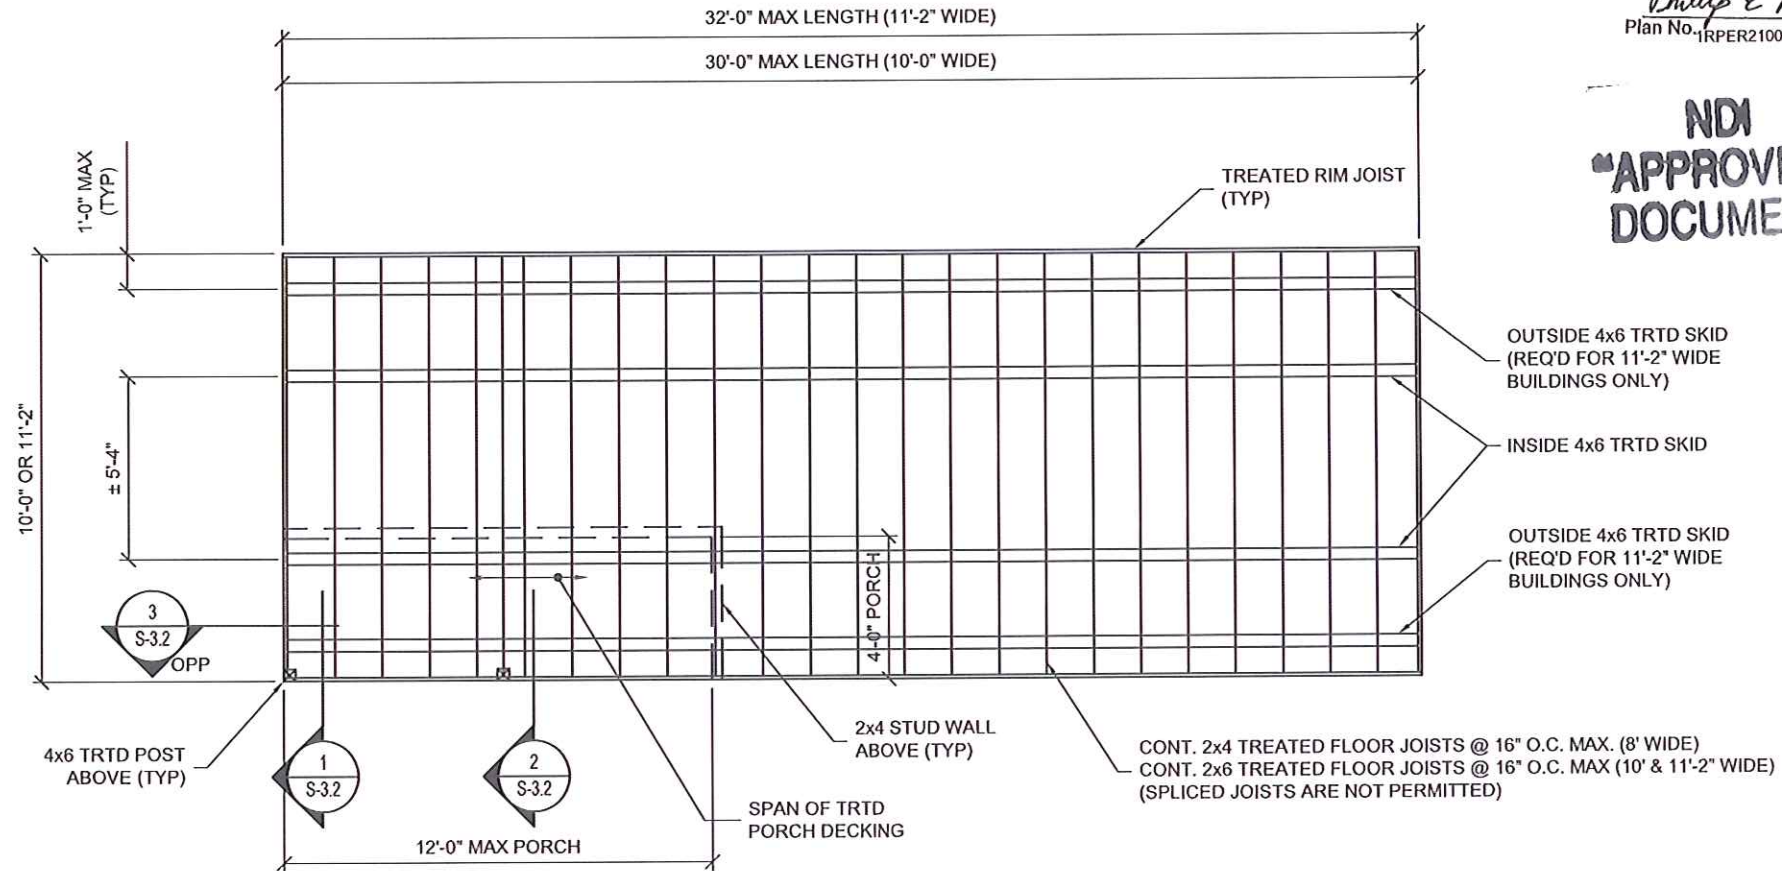
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DATE:	09-28-2021
DRAWN BY:	KLN
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REVISION:	

SHEET NUMBER
S-11-LB
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Phillip E Robbins
Plan No. 1RPER210076 Date: 03/27/2023

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SIDE LOFTED BARN CABIN FLOOR FRAMING PLAN (OPTIONAL)



LOFTED BARN--FLORIDA--WIND=160 MPH--FBC 2020

Kevin L. Nolan

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DN:
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Nolan, c=US
Date: 2023.03.22 13:46:31 -05'00'

Weather King
PORTABLE BUILDINGS

PROJECT NO:	
DATE:	09-28-2021
DRAWN BY:	KLN
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REVISION:	


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S-12-LB

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DELUXE LOFTED BARN CABIN FLOOR FRAMING PLAN (OPTIONAL)



LOFTED BARN--FLORIDA--WIND=160 MPH--FBC 2020

Weather King
PORTABLE BUILDINGS

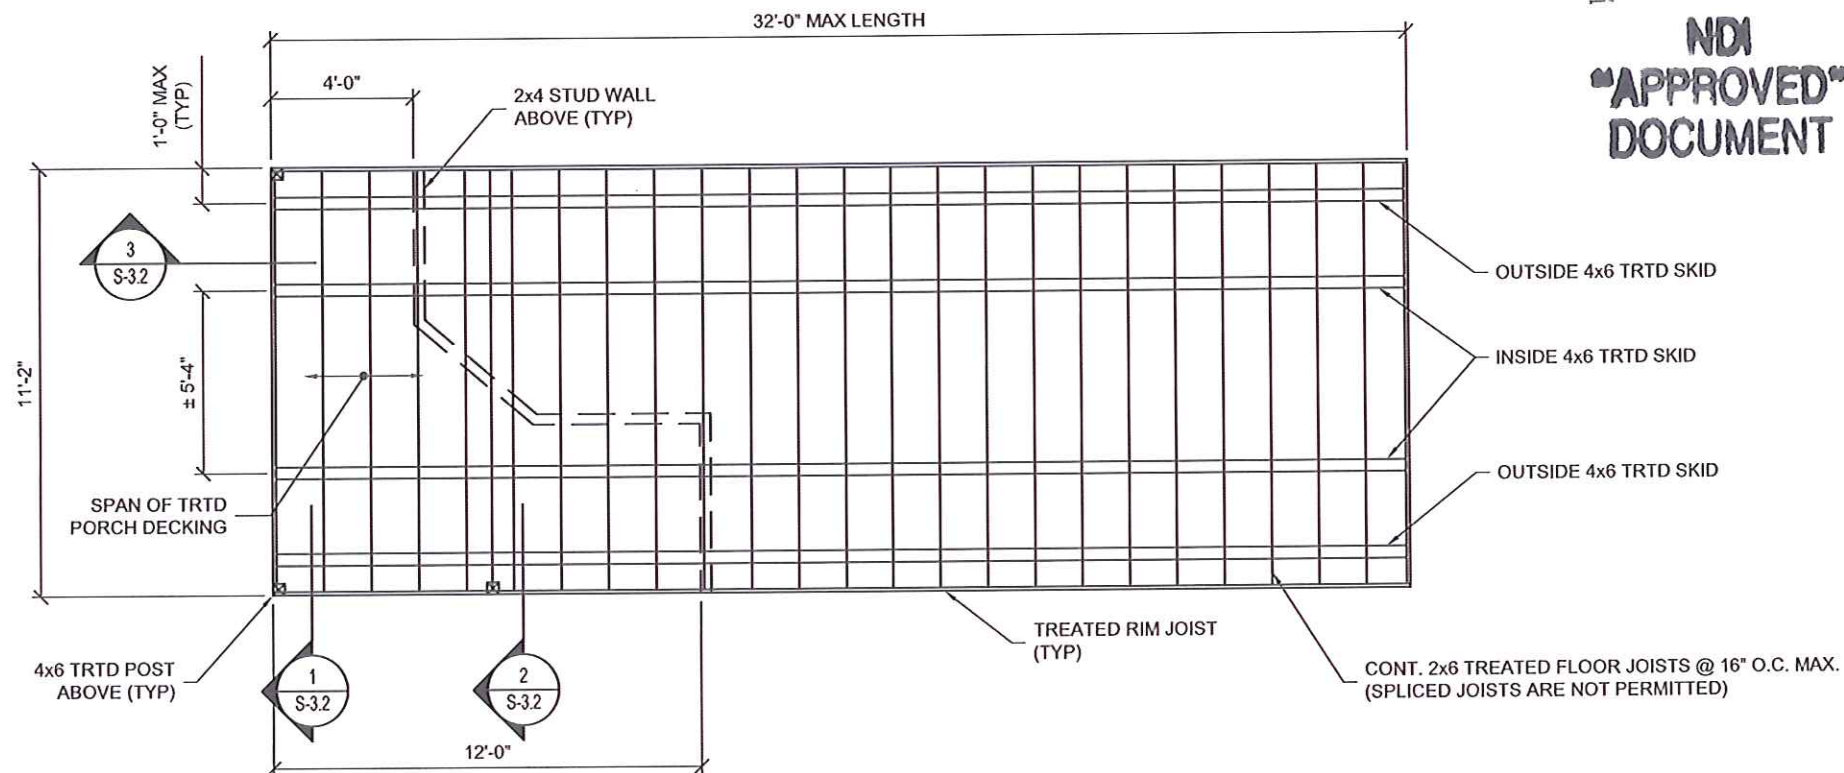PROJECT NO:	
DATE:	09-28-2021
DRAWN BY:	KLN
CHECKED BY:	KLN
REVISION:	


SHEET NUMBER

S-13-LE

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 Florida PE-49070
Phillip E Robbins
 Plan No. 1RPER210076 Date: 03/27/2023



CENTER PORCH CABIN FLOOR FRAMING PLAN (OPTIONAL)

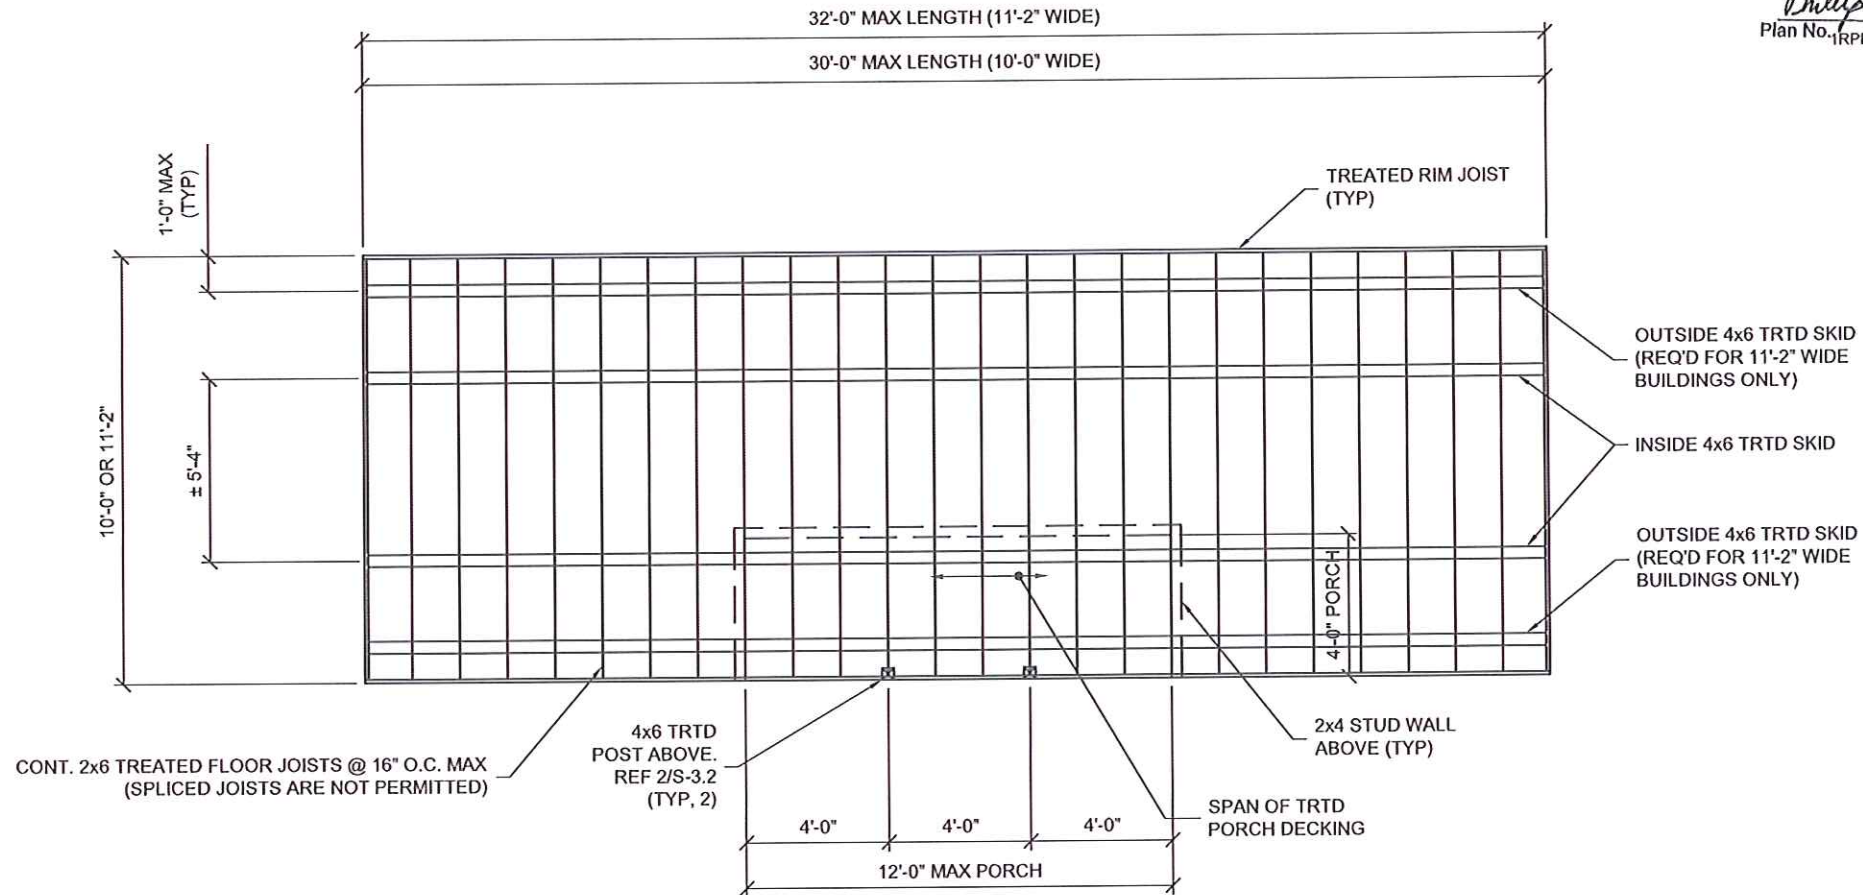

LOFTED BARN--FLORIDA--WIND=160 MPH--FBC 2020

Kevin L. Nolan

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 c=US
 Date: 2023.03.22 13:47:28 -05'00'

Weather King
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PROJECT NO:
 DATE: 09-28-2021
 DRAWN BY: KLN
 CHECKED BY: KLN
 REVISION: 03-22-2023


SHEET NUMBER

S-14-LB

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Florida PE-49070
Phillip E Robbins
Plan No. 1RPER210076 Date: 03/27/2023



LOFTED BARN w/ ROLL-UP DOOR FLOOR FRAMING PLAN (OPTIONAL)

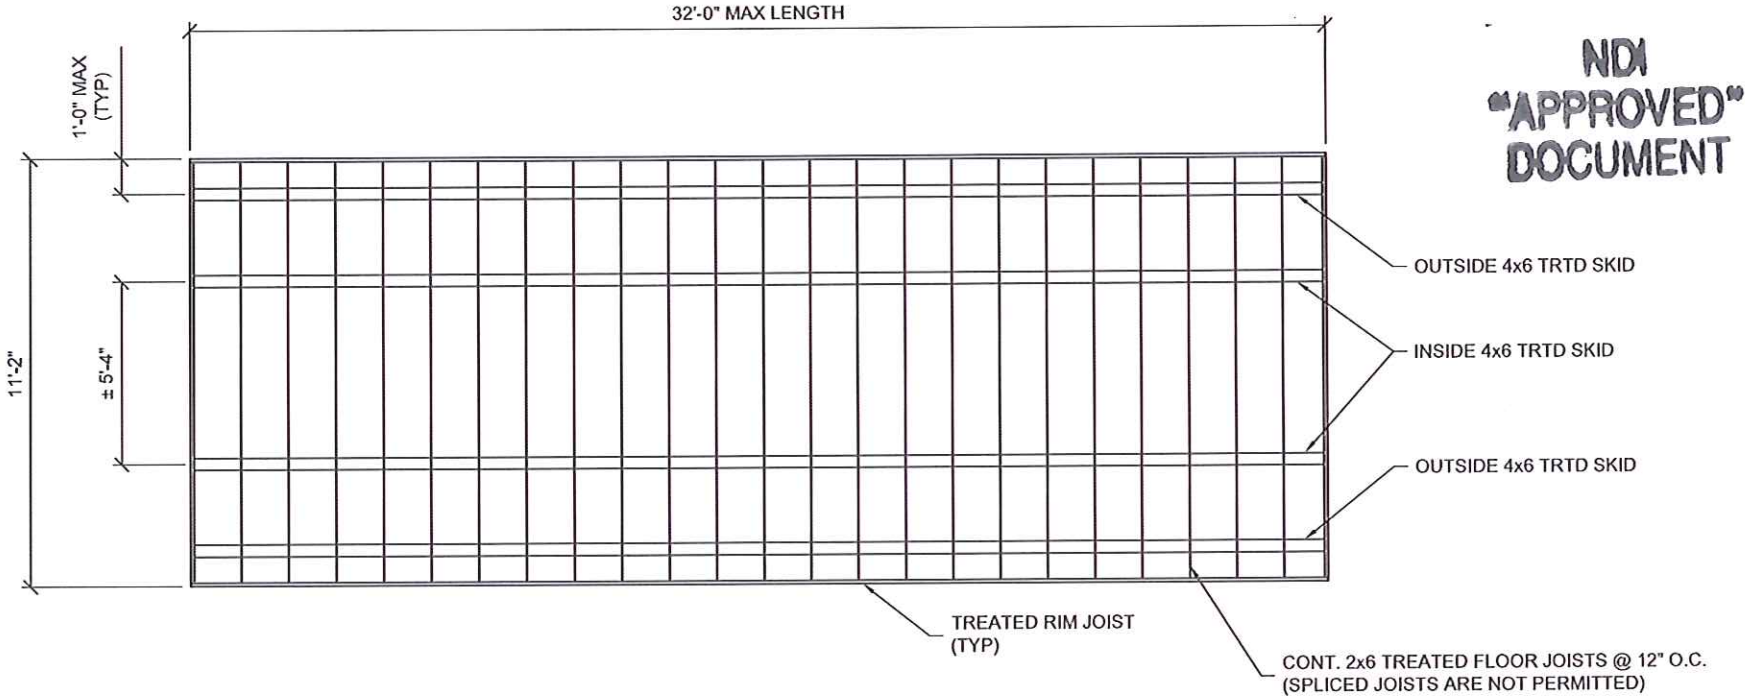

LOFTED BARN--FLORIDA--WIND=160 MPH--FBC 2020

Kevin L. Nolan

Digitally signed by Kevin Nolan
DN:
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0179D834EF80000196AF, cn=Kevin Nolan,
c=US
Date: 2023.03.22 13:48:25 -05'00'



PROJECT NO:	
DATE:	09-28-2021
DRAWN BY:	KLN
CHECKED BY:	KLN
REVISION:	03-22-2023

SHEET NUMBER


S-15-LB

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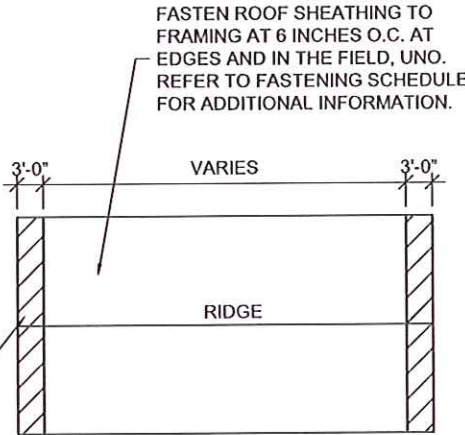
Approved by Phillip E Robbins
Florida PE-49070
Phillip E Robbins
Plan No. 1RPER210076 Date: 03/27/2023

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ROOF FRAMING PLAN

FASTEN ROOF SHEATHING TO FRAMING AT 4 INCHES O.C. AT EDGES AND IN THE FIELD WITHIN THE END STRIP AT EACH ENDWALL. REFER TO FASTENING SCHEDULE FOR ADDITIONAL INFORMATION.

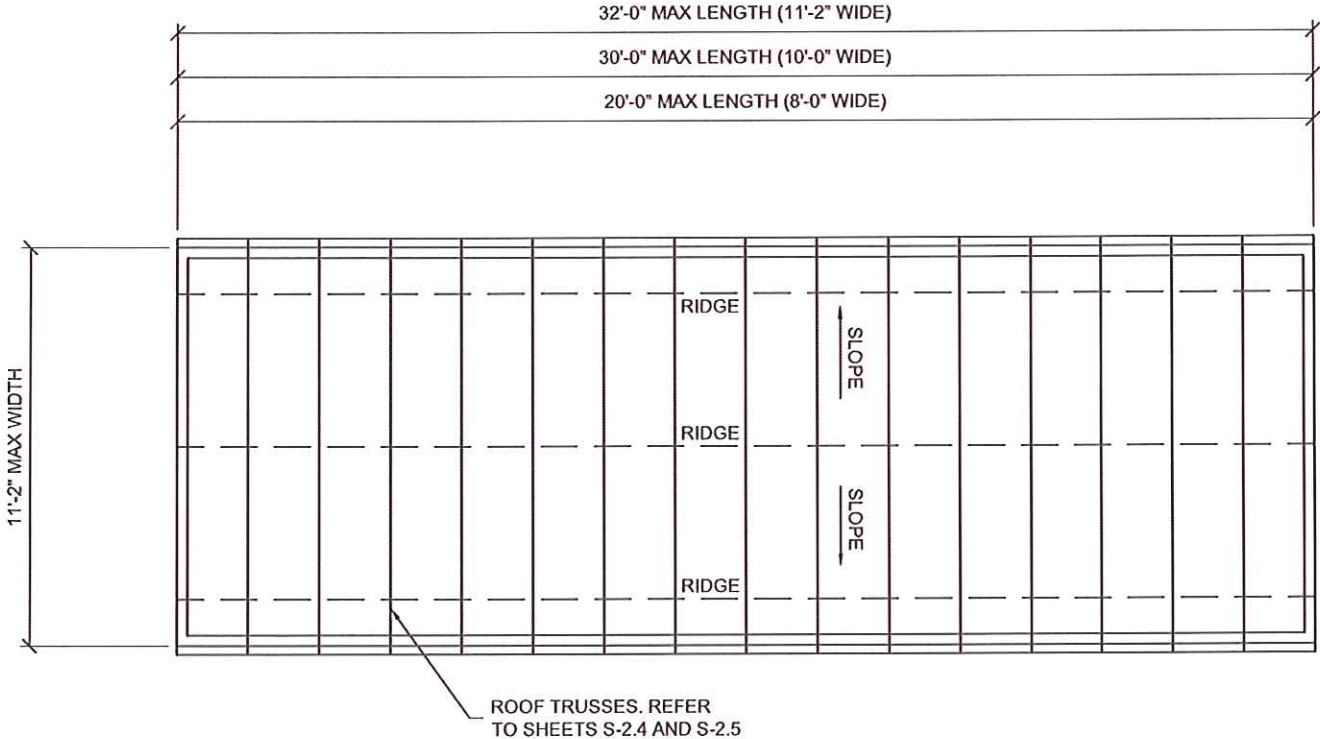

ROOF SHEATHING DIAGRAM



LOFTED BARN--FLORIDA--WIND=160 MPH--FBC 2020


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cn=Kevin Nolan, c=US
Date: 2023.03.22 13:49:25 -05'00'

Weather King
PORTABLE BUILDINGS

PROJECT NO:
DATE: 09-28-2021
DRAWN BY: KLN
CHECKED BY: KLN
REVISION: 03-22-2023

SHEET NUMBER
S-16-LB
SCALE: NOT TO SCALE

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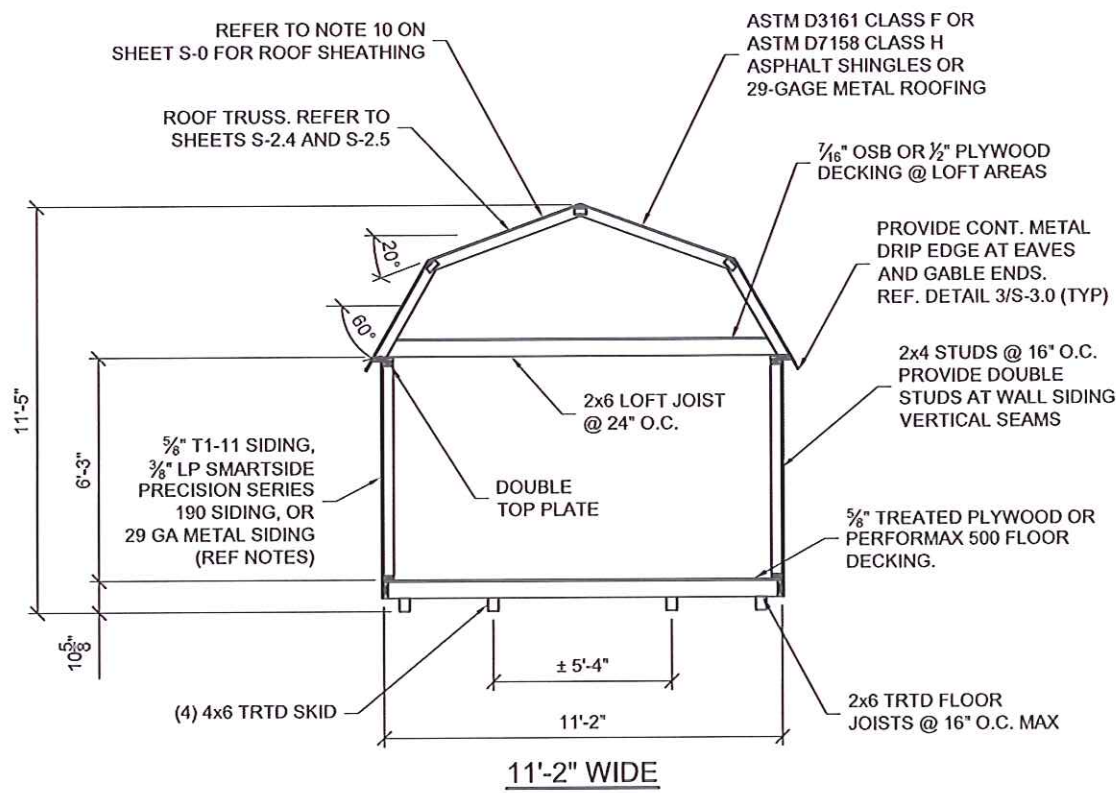

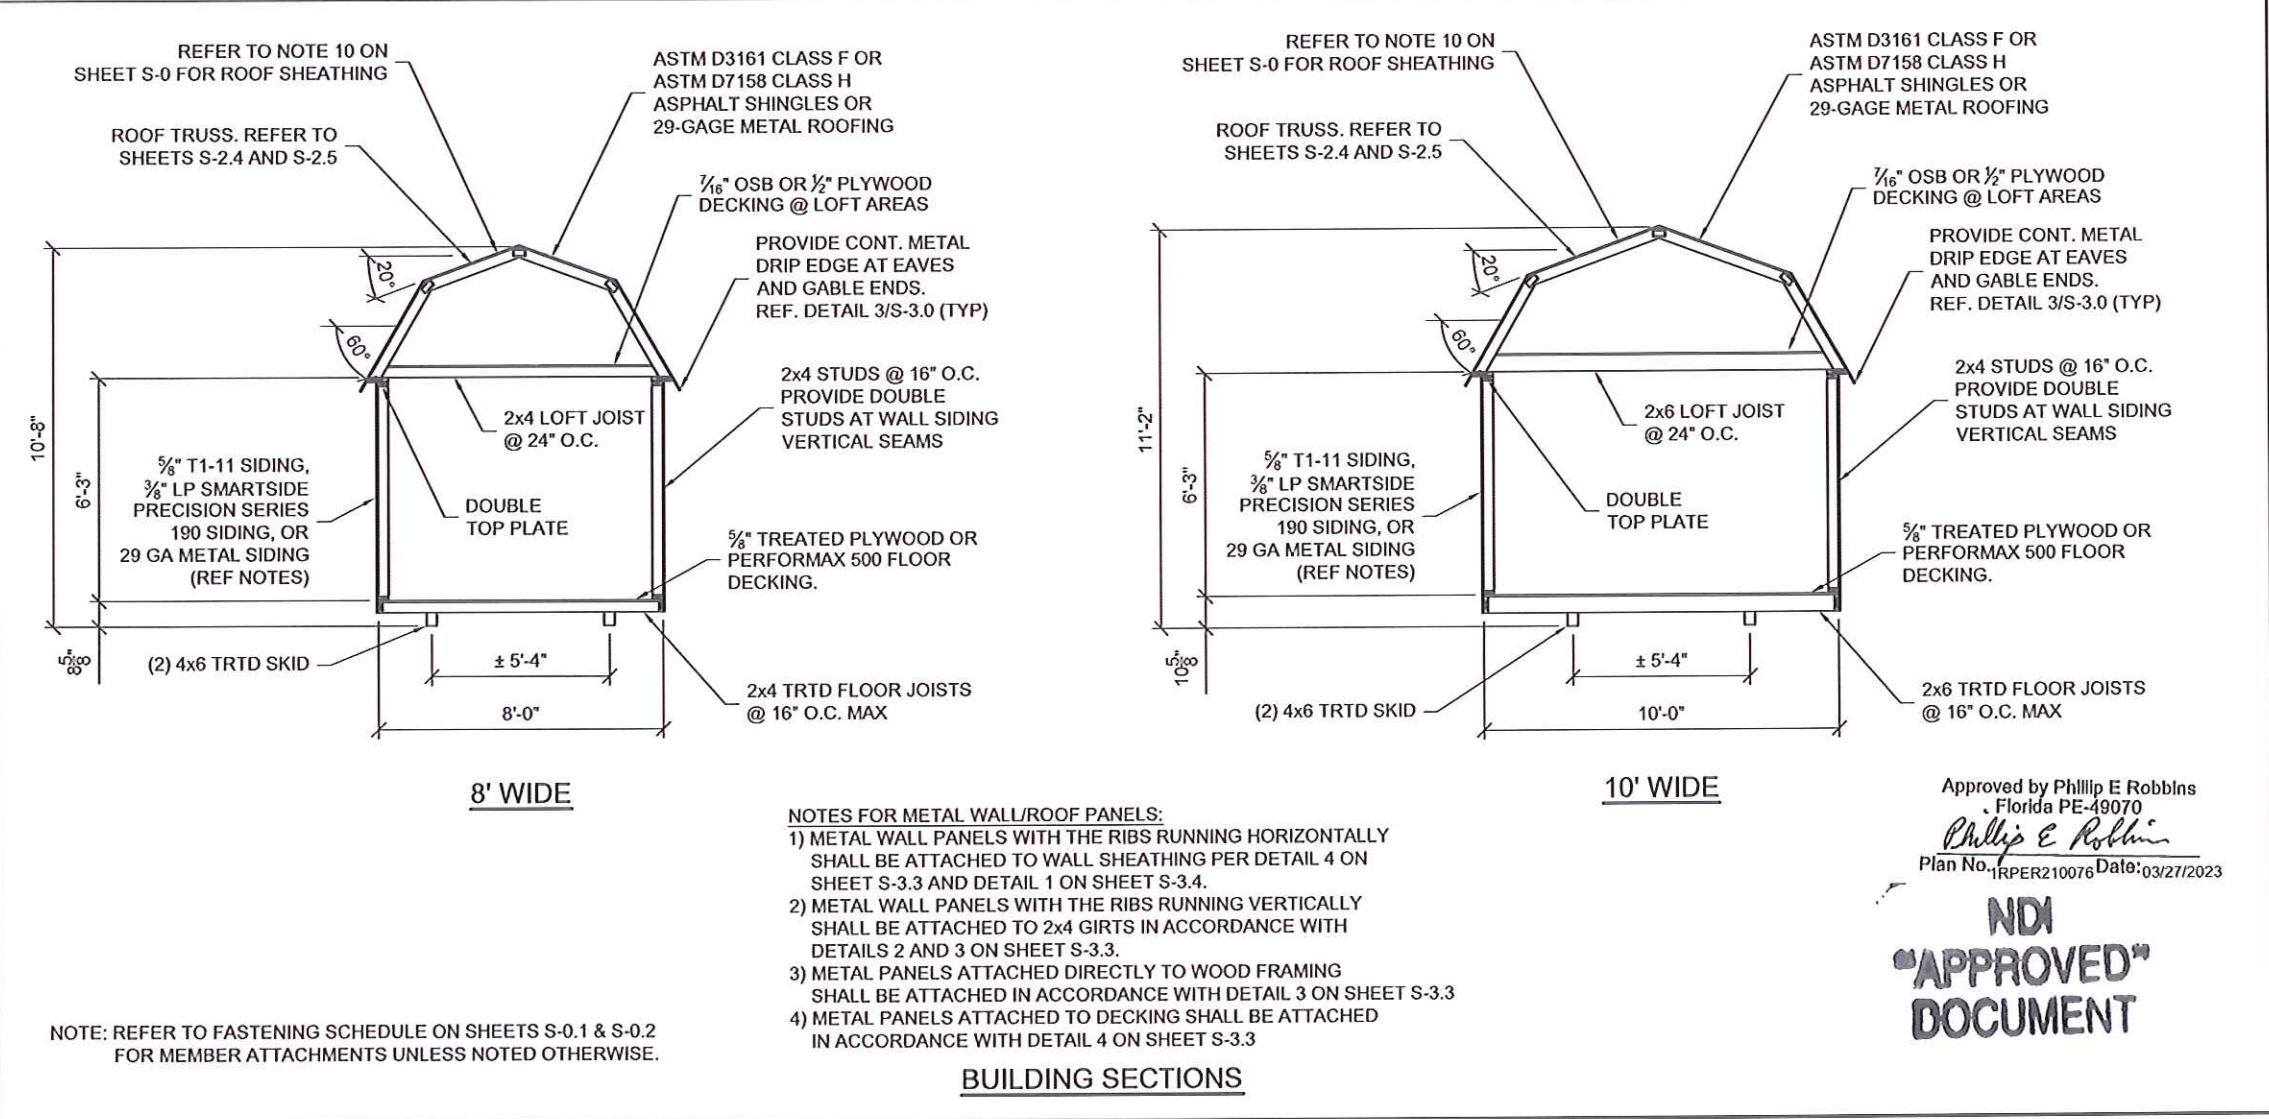
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LOFTED BARN--FLORIDA--WIND=160 MPH--FBC 2020

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cn=Kevin Nolan, c=US
Date: 2023.03.22 13:49:58 -05'00'

PROJECT NO:		SHEET NUMBER S-2.0-LB SCALE: 1/4" = 1'-0"
DATE:	09-28-2021	
DRAWN BY:	KLN	
CHECKED BY:	KLN	
REVISION:		



- NOTES FOR METAL WALL/ROOF PANELS:
- 1) METAL WALL PANELS WITH THE RIBS RUNNING HORIZONTALLY SHALL BE ATTACHED TO WALL SHEATHING PER DETAIL 4 ON SHEET S-3.3 AND DETAIL 1 ON SHEET S-3.4.
 - 2) METAL WALL PANELS WITH THE RIBS RUNNING VERTICALLY SHALL BE ATTACHED TO 2x4 GIRTS IN ACCORDANCE WITH DETAILS 2 AND 3 ON SHEET S-3.3.
 - 3) METAL PANELS ATTACHED DIRECTLY TO WOOD FRAMING SHALL BE ATTACHED IN ACCORDANCE WITH DETAIL 3 ON SHEET S-3.3
 - 4) METAL PANELS ATTACHED TO DECKING SHALL BE ATTACHED IN ACCORDANCE WITH DETAIL 4 ON SHEET S-3.3

Approved by Phillip E Robbins
Florida PE-49070
Phillip E Robbins
Plan No. 1RPER210076 Date: 03/27/2023

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NOTE: REFER TO FASTENING SCHEDULE ON SHEETS S-0.1 & S-0.2 FOR MEMBER ATTACHMENTS UNLESS NOTED OTHERWISE.

BUILDING SECTION



LOFTED BARN--FLORIDA--WIND=160 MPH--FBC 2020


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cn=Kevin Nolan, c=US
Date: 2023.03.22 13:50:28 -05'00'



PROJECT NO:	
DATE:	09-28-2021
DRAWN BY:	KLN
CHECKED BY:	KLN
REVISION:	

SHEET NUMBER
S-21-LB
SCALE: 1/4" = 1'-0"

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KEVIN L. NOLAN
LICENSE
No. 77209
STATE OF FLORIDA
PROFESSIONAL ENGINEER

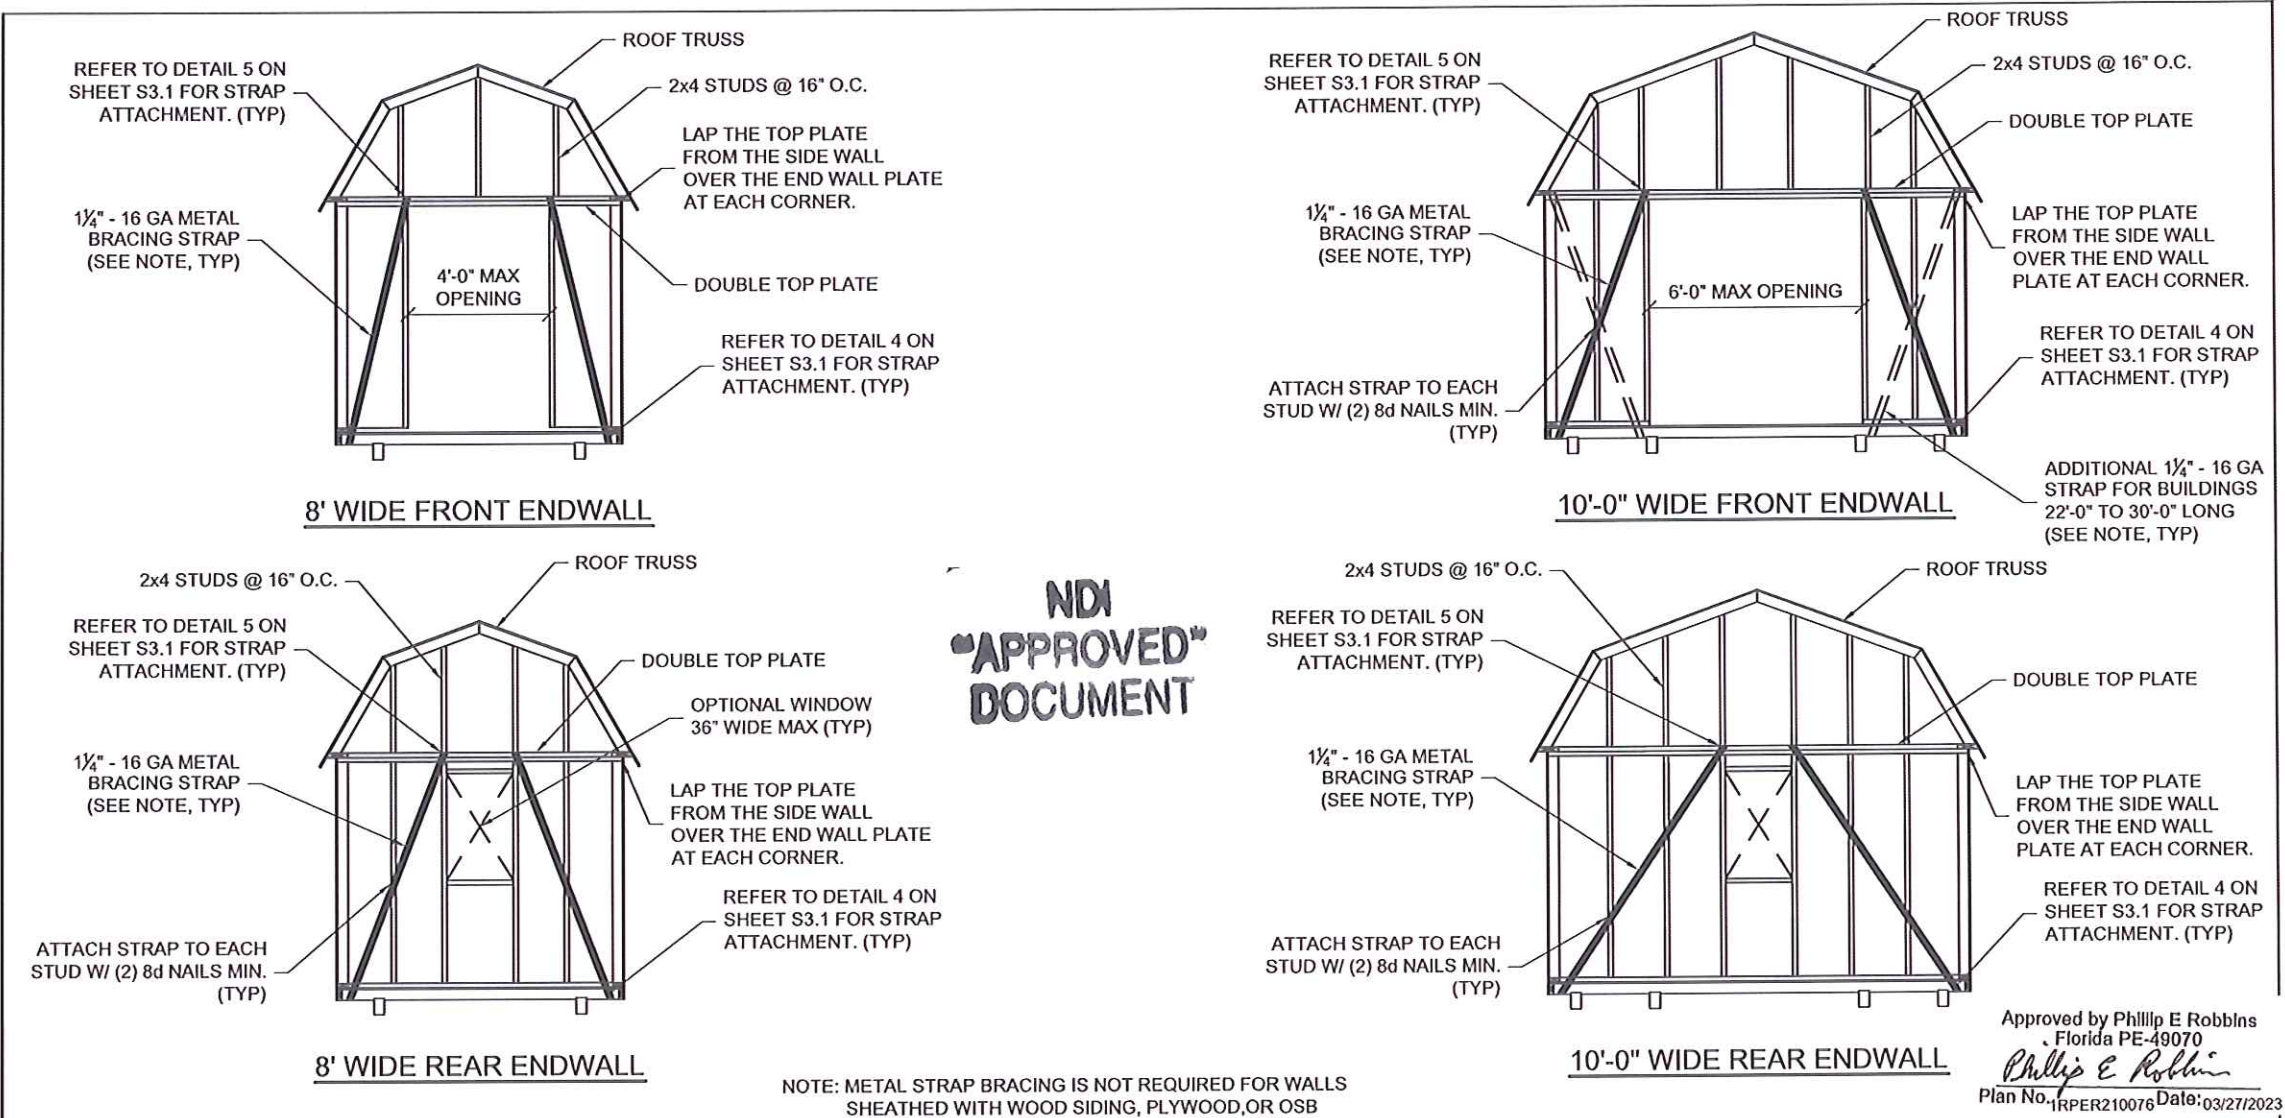LOFTED BARN--FLORIDA--WIND=160 MPH--FBC 2020


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c=US
Date: 2023.03.22 13:51:05 -05'00'



PROJECT NO:	
DATE:	09-28-2021
DRAWN BY:	KLN
CHECKED BY:	KLN
REVISION:	

SHEET NUMBER
S-22-LB
SCALE: NOT TO SCALE

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LOFTED BARN--FLORIDA--WIND=160 MPH--FBC 2020

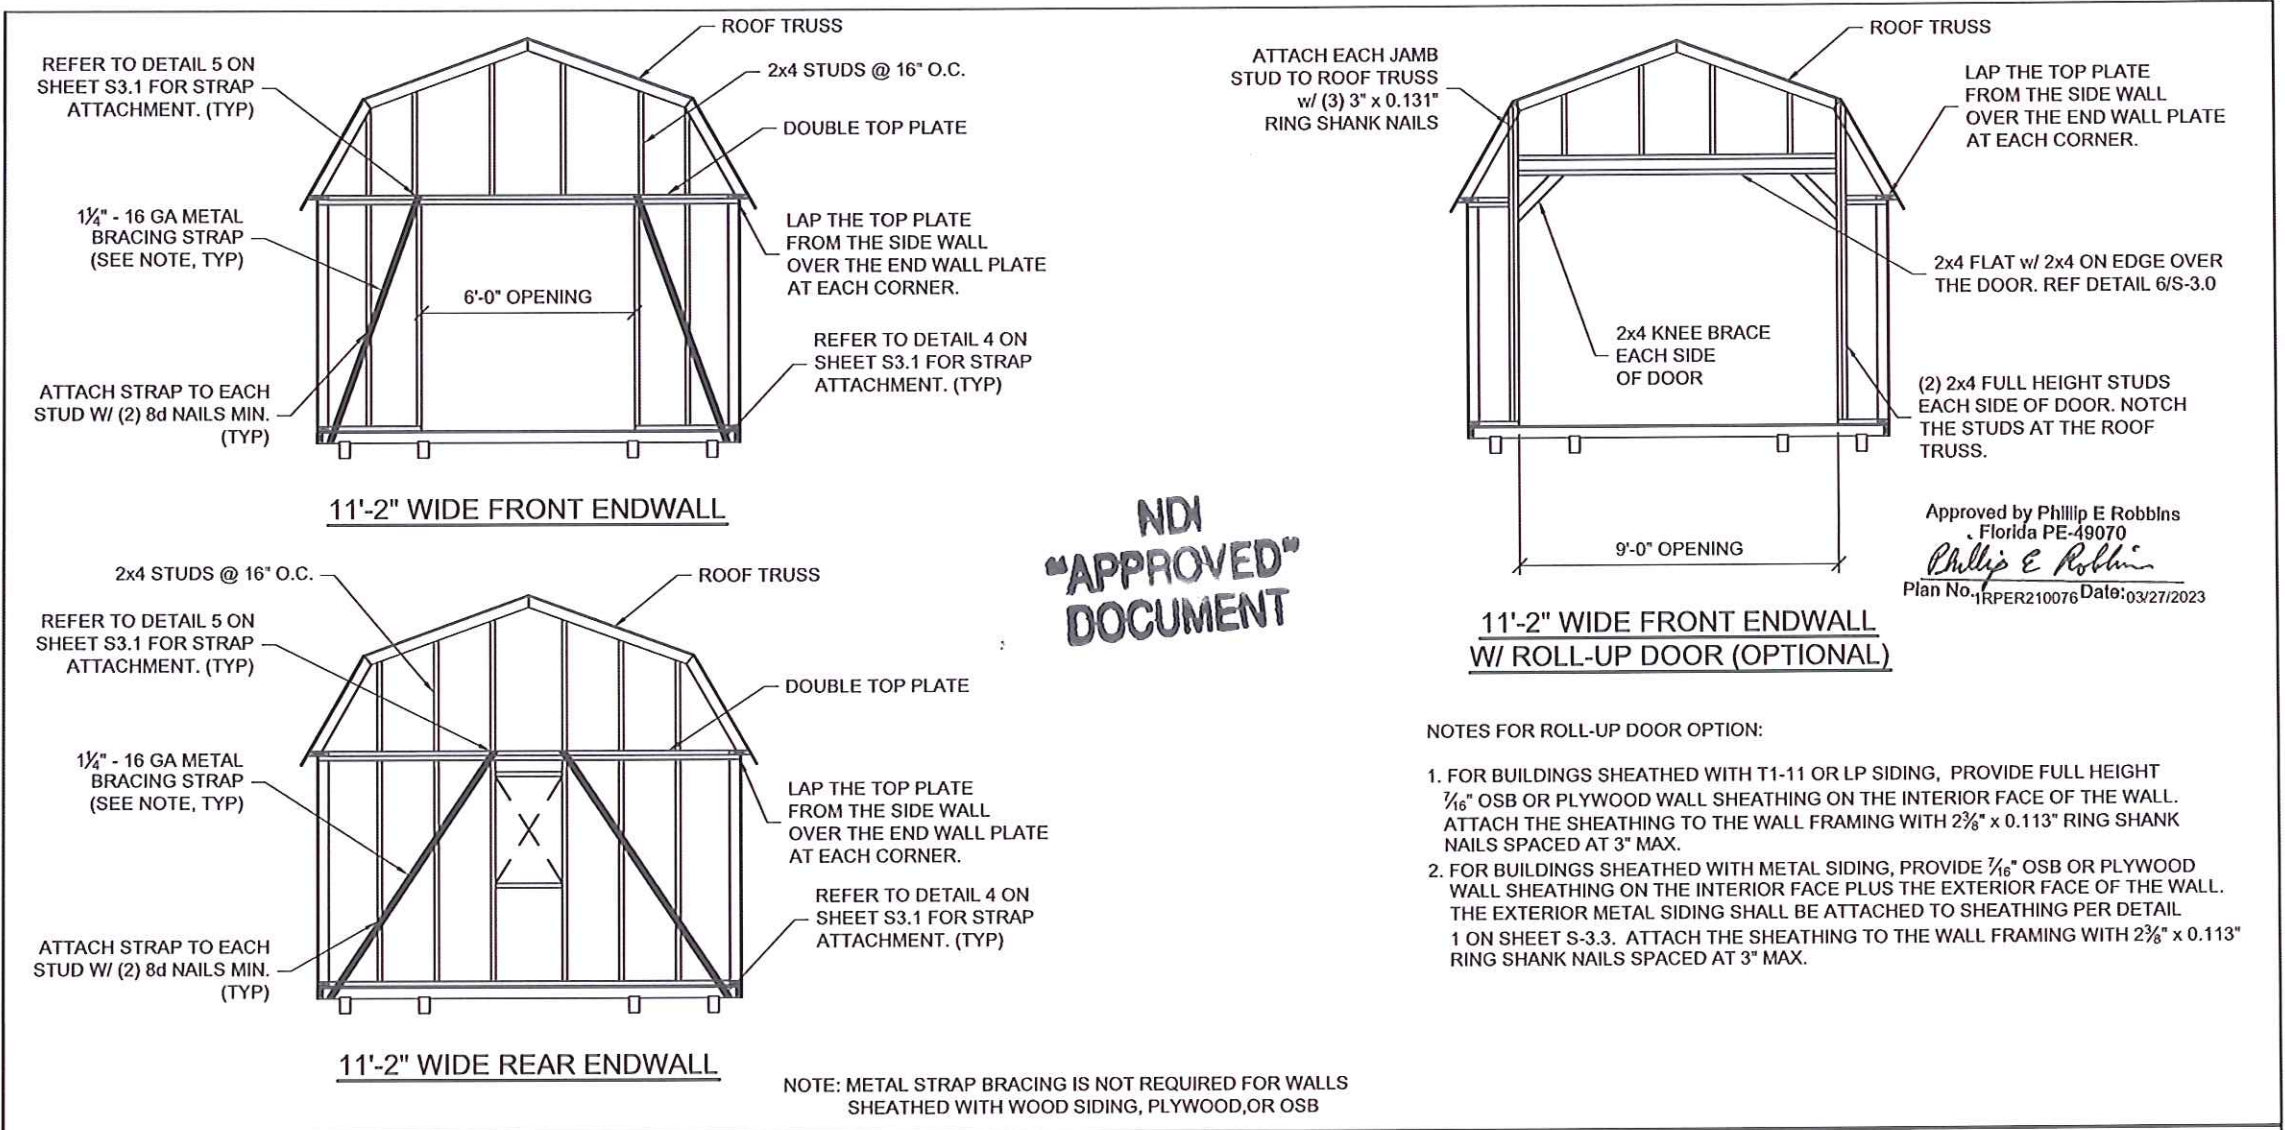
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000179D834EF80000196AF, cn=Kevin Nolan, c=US
Date: 2023.03.22 13:52:40 -05'00'

PROJECT NO:
DATE: 09-28-2021
DRAWN BY: KLN
CHECKED BY: KLN
REVISION:

SHEET NUMBER
S-23-LB
SCALE: NOT TO SCALE


GENERAL NOTES:

1. REFER TO SHEET S-0 FOR DESIGN LOADS.
2. MAXIMUM TRUSS SPACING = 24" O.C. UNLESS NOTED OTHERWISE.
3. TRUSS TOP CHORD SHALL BE BRACED W/ STRUCTURAL WOOD SHEATHING ATTACHED DIRECTLY TO TRUSS MEMBERS.
4. ALL TRUSS MEMBERS ARE TO BE SPF #2 OR BETTER.
5. TRUSS PLATES ARE TO BE A MINIMUM OF 20 GAGE (MT20) HYDRAULICALLY PRESSED IN PLACE EACH SIDE OF TRUSS.
6. REACTIONS DUE TO WIND ARE BASED ON MWFRS END ZONE PRESSURES. INDIVIDUAL MEMBERS DESIGNED FOR COMPONENTS AND CLADDING WIND PRESSURE.
7. DEFLECTION MEETS L/240 LIVE LOAD AND L/180 TOTAL LOAD.
8. LOAD DURATION ADJUSTMENT FACTORS:
ROOF LIVE: 1.25
WIND: 1.60
9. REPETITIVE MEMBER INCREASE: 1.15
10. HORIZONTAL THRUST IS TO BE RESISTED BY LOFT JOISTS. REFER TO SHEETS S-2.0, S-2.1, AND S-3.0 FOR LOFT JOIST SIZE, AND ATTACHMENT INFORMATION.

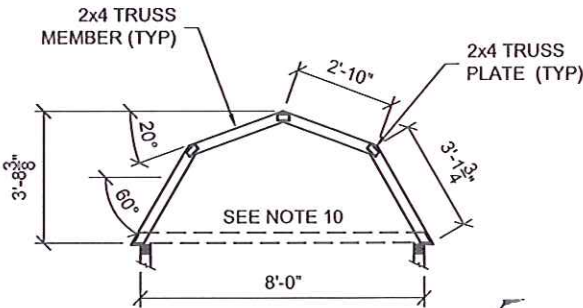

MAX REACTIONS
HORIZ: 108 LBS.
NET UPLIFT: -175 LBS.
GRAVITY: 269 LBS.

8' WIDE LOFTED BARN TRUSS

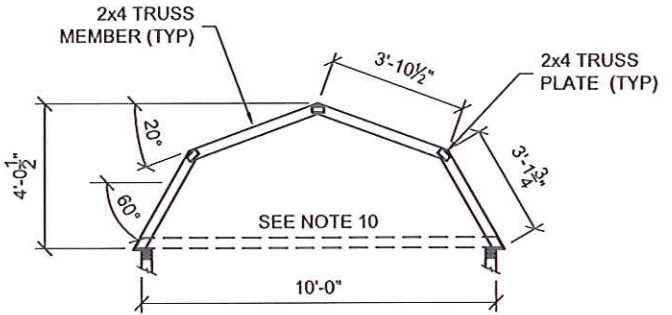


MAX REACTIONS
HORIZ: 121 LBS.
NET UPLIFT: -227 LBS.
GRAVITY: 333 LBS.

10' WIDE LOFTED BARN TRUSS

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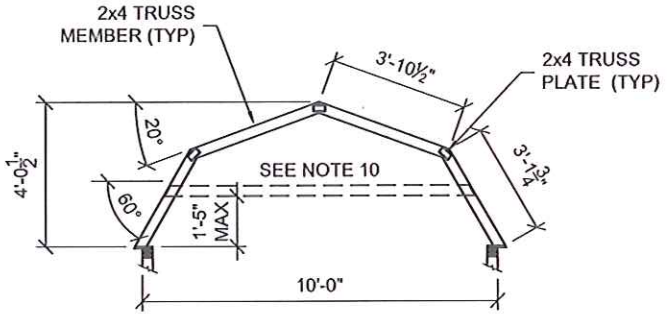
Approved by Phillip E Robbins
Florida PE-49070

Phillip E Robbins
Plan No. 1RPER210076 Date: 03/27/2023

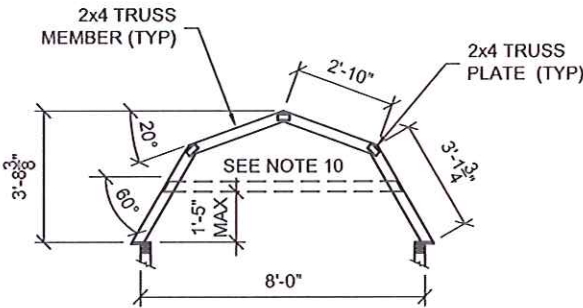

MAX REACTIONS
HORIZ: 108 LBS.
NET UPLIFT: -179 LBS.
GRAVITY: 250 LBS.

8' WIDE LOFTED BARN TRUSS (OPTIONAL)



MAX REACTIONS
HORIZ: 121 LBS.
NET UPLIFT: -231 LBS.
GRAVITY: 314 LBS.

10' WIDE LOFTED BARN TRUSS (OPTIONAL)



LOFTED BARN--FLORIDA--WIND=160 MPH--FBC 2020

Kevin L. Nolan

Digitally signed by Kevin Nolan
DN:
0.9.2342.19200300.100.1.1=A01410C000
00179D834EF80000196AF, cn=Kevin
Nolan, c=US
Date: 2023.03.22 13:53:18 -05'00'

Weather King®
PORTABLE BUILDINGS

PROJECT NO:

DATE: 09-28-2021

DRAWN BY: KLN

CHECKED BY: KLN


REVISION:

SHEET NUMBER

S-24-LB


SCALE: 1/4" = 1'-0"

1. This item has been electronically signed and sealed by Kevin L. Nolan, PE on 03/22/2023 using a digital signature.
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MAX REACTIONS
HORIZ: 125 LBS.
NET UPLIFT: -258 LBS.
GRAVITY: 370 LBS.

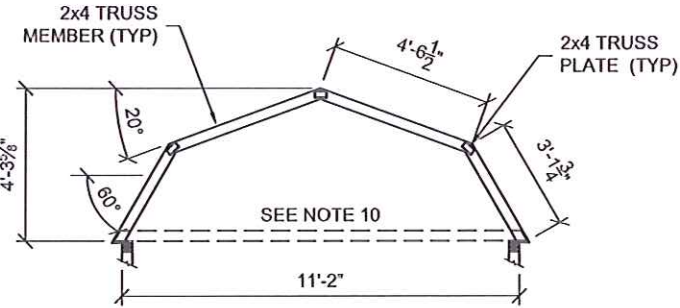11'-2" WIDE LOFTED BARN TRUSS



MAX REACTIONS
HORIZ: 125 LBS.
NET UPLIFT: -262 LBS.
GRAVITY: 351 LBS.

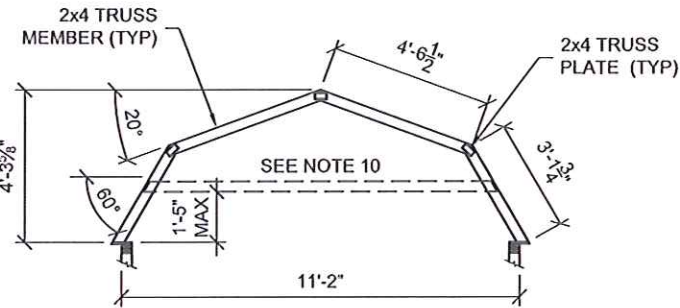11'-2" WIDE LOFTED BARN TRUSS (OPTIONAL)

Approved by Phillip E Robbins
Florida PE-49070
Phillip E Robbins
Plan No. 1RPER210076 Date: 03/27/2023

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DOCUMENT



LOFTED BARN--FLORIDA--WIND=160 MPH--FBC 2020

Kevin Nolan


Digitally signed by Kevin Nolan
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cn=Kevin Nolan, c=US
Date: 2023.03.22 13:53:54 -05'00'

Weather King
PORTABLE BUILDINGS

PROJECT NO:	
DATE:	09-28-2021
DRAWN BY:	KLN
CHECKED BY:	KLN
REVISION:	

SHEET NUMBER
S-25-LB
SCALE: 1/4" = 1'-0"

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LOFTED BARN--FLORIDA--WIND=160 MPH--FBC 2020

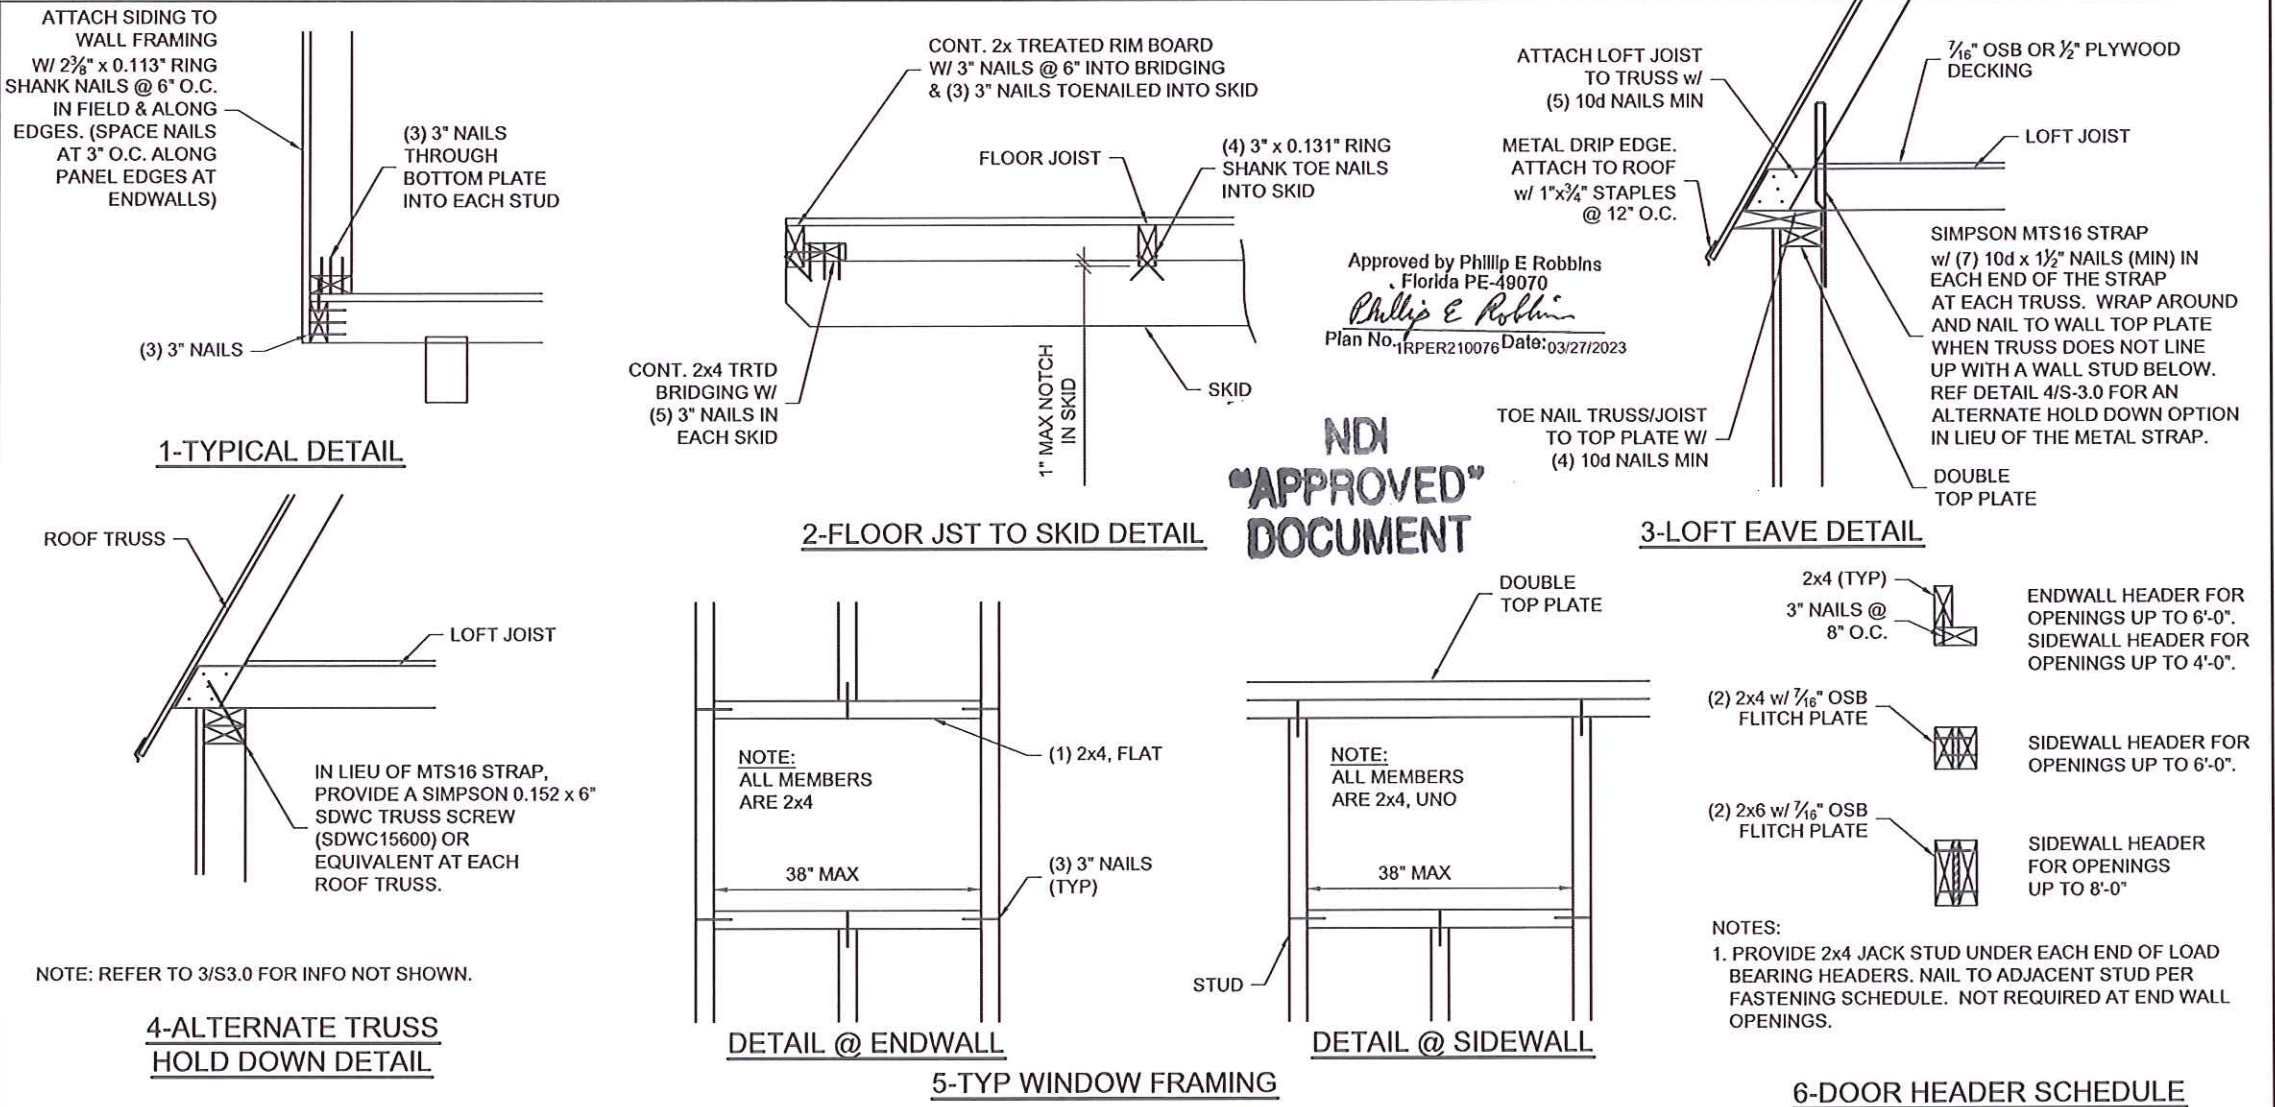NOTE: REFER TO FASTENING SCHEDULE ON SHEETS S-0.1 AND S-0.2 FOR ATTACHMENT INFORMATION NOT NOTED ON THIS SHEET.

Kevin L. Nolan


Digitally signed by Kevin Nolan
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9D834EF80000196AF, cn=Kevin Nolan, c=US
Date: 2023.03.22 13:54:36 -05'00'



PROJECT NO:	
DATE:	09-28-2021
DRAWN BY:	KLN
CHECKED BY:	KLN
REVISION:	

SHEET NUMBER
S-3.0-LB
SCALE: 1"=1'-0

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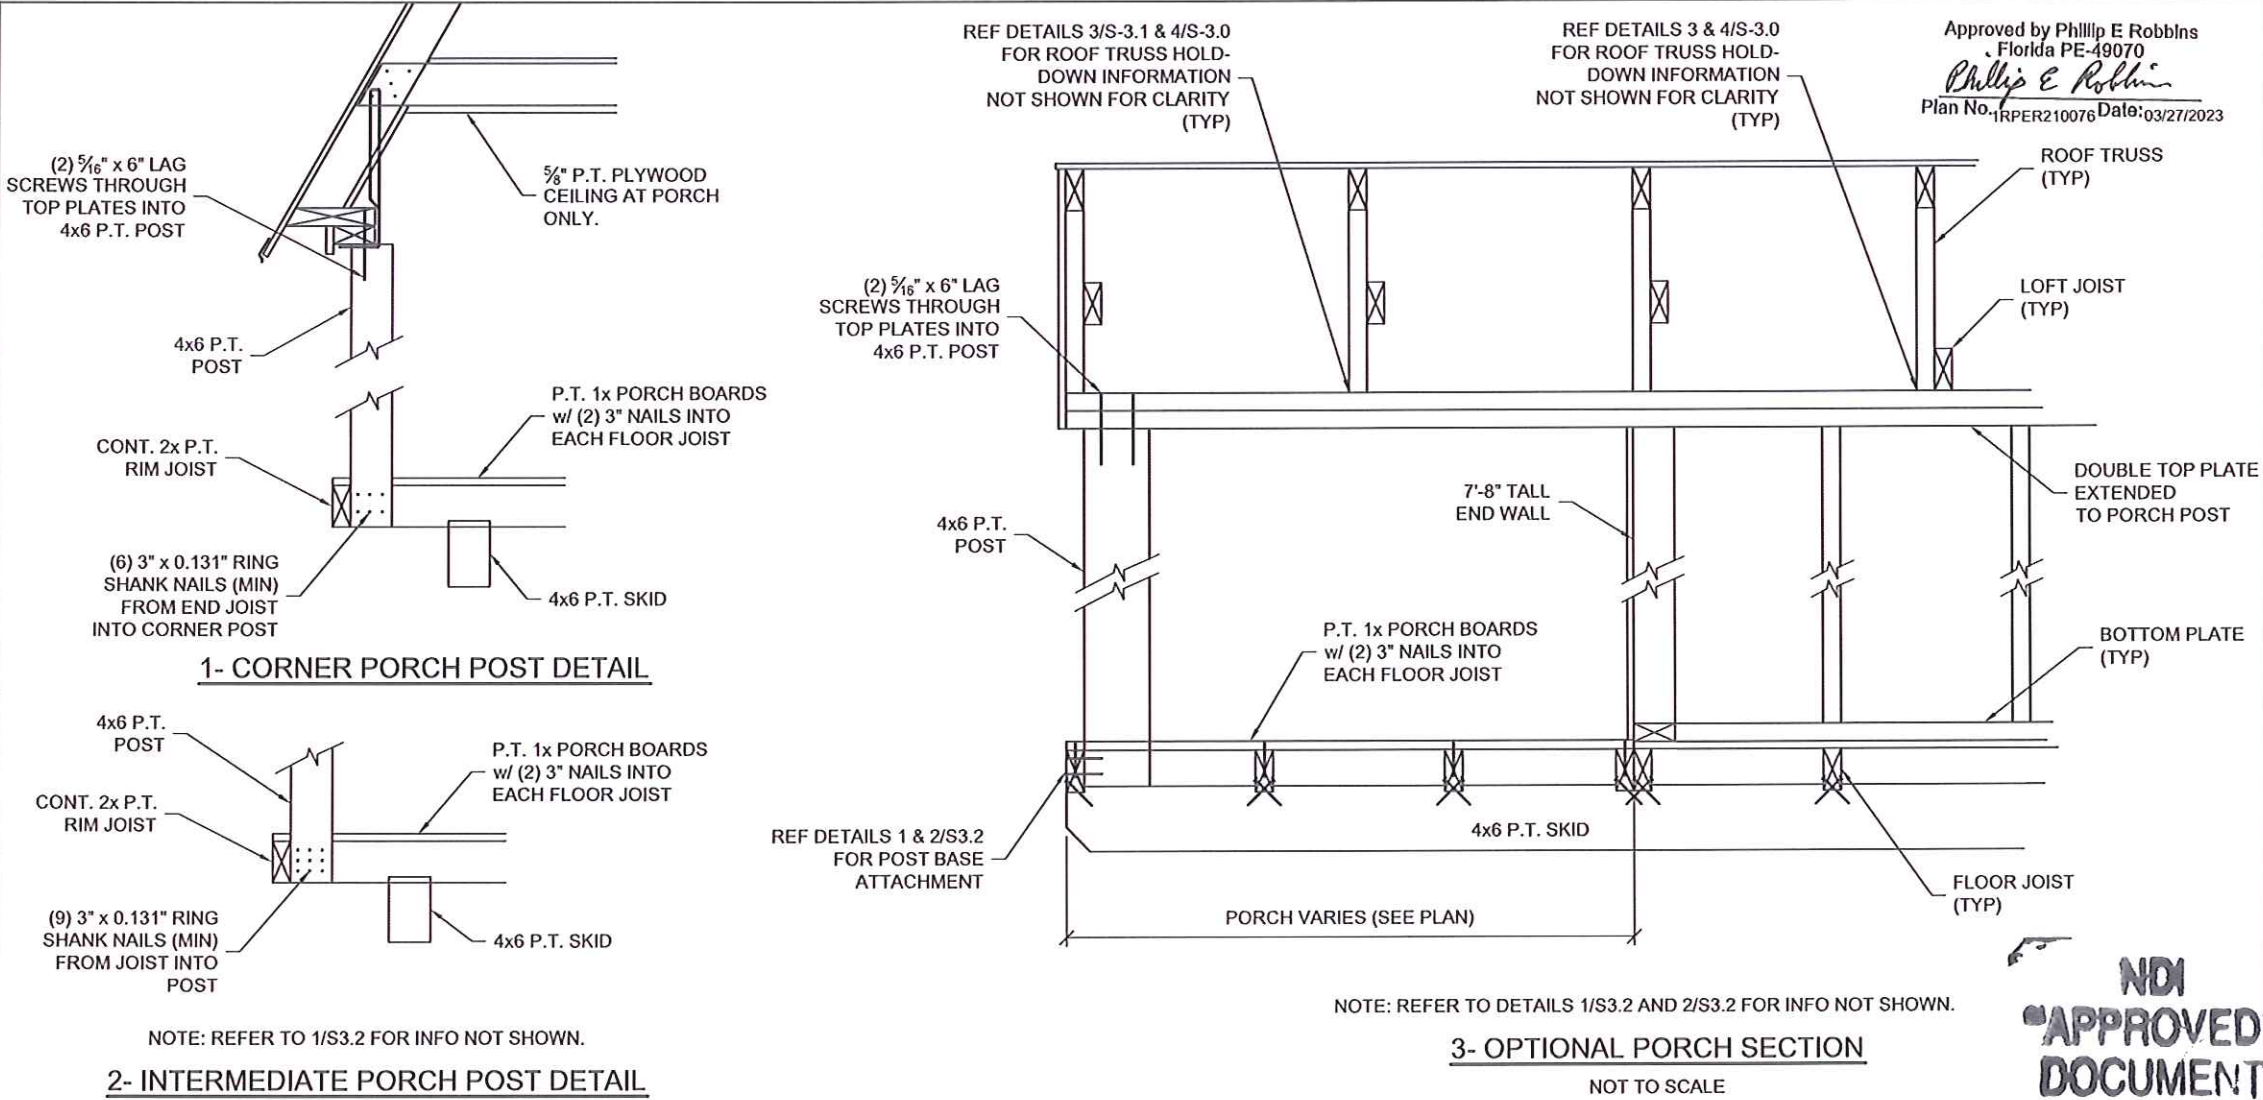
1. This item has been electronically signed and sealed by Kevin L Nolan, PE on 03/22/2023 using a digital signature.
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LOFTED BARN--FLORIDA--WIND=160 MPH--FBC 2020

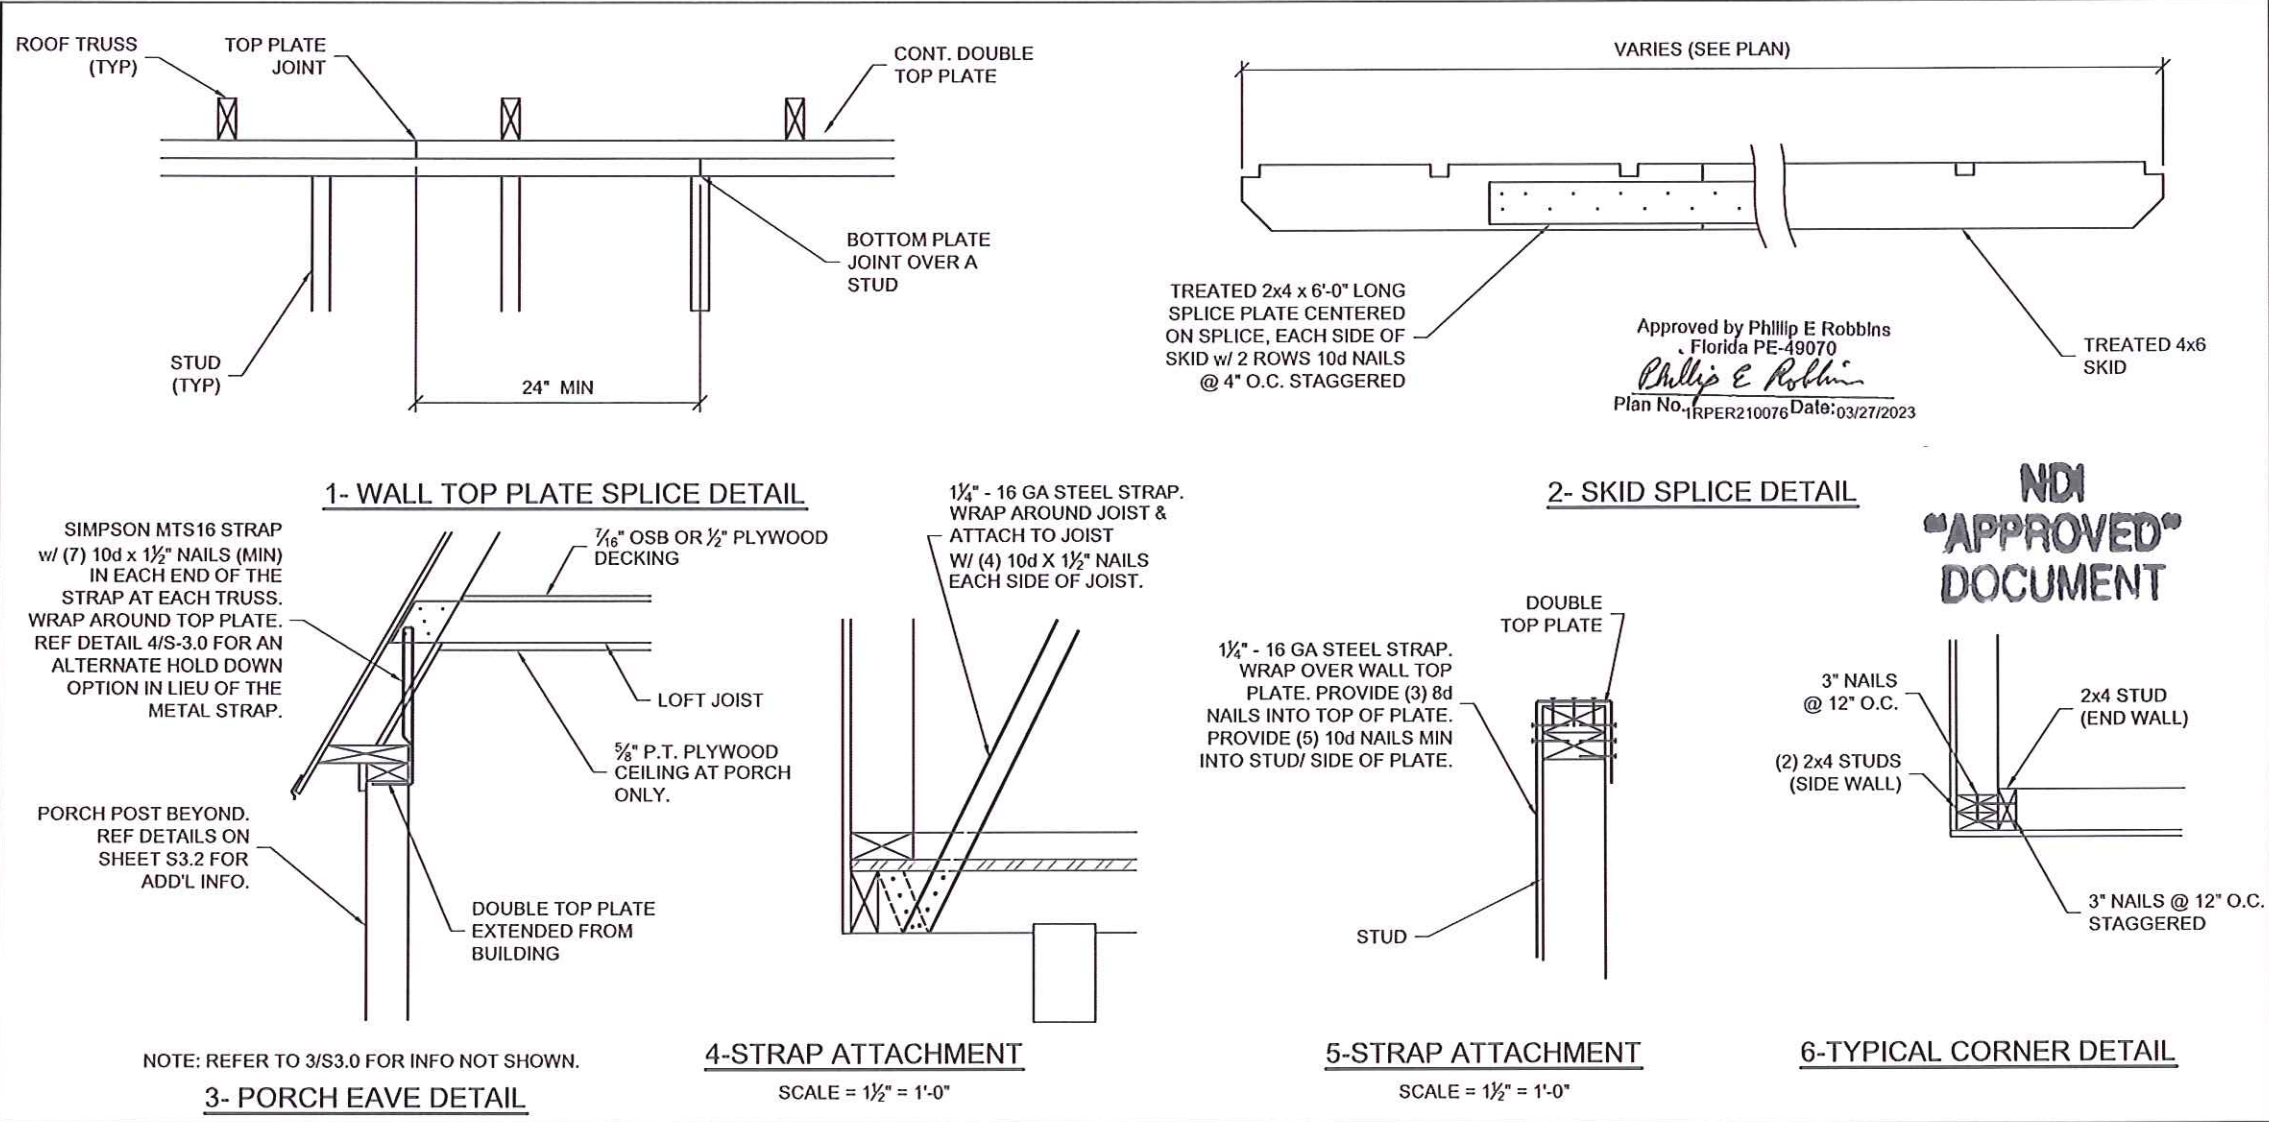NOTE: REFER TO FASTENING SCHEDULE ON SHEETS S-0.1 AND S-0.2 FOR ATTACHMENT INFORMATION NOT NOTED ON THIS SHEET.

Digitally signed by Kevin Nolan
DN:
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9D834EF80000196AF, cn=Kevin Nolan, c=US
Date: 2023.03.22 13:55:27 -05'00'

PROJECT NO:		SHEET NUMBER S-31-LB SCALE: 1"=1'-0
DATE:	09-28-2021	
DRAWN BY:	KLN	
CHECKED BY:	KLN	
REVISION:		



LOFTED BARN--FLORIDA--WIND=160 MPH--FBC 2020

NOTE: REFER TO FASTENING SCHEDULE ON SHEETS S-0.1 AND S-0.2 FOR ATTACHMENT INFORMATION NOT NOTED ON THIS SHEET.

Kevin L. Nolan


Digitally signed by Kevin L. Nolan
DN:
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D834EF80000156AF, cn=Kevin L. Nolan, c=US
Date: 2023.03.22 13:56:13 -05'00'





PROJECT NO:	
DATE:	09-28-2021
DRAWN BY:	KLN
CHECKED BY:	KLN
REVISION:	

SHEET NUMBER
S-3.2-LB
SCALE: 1"=1'-0"

1. This item has been electronically signed and sealed by Kevin L. Nolan, PE on 03/22/2023 using a digital signature.
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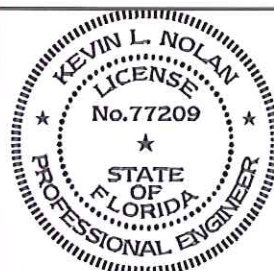


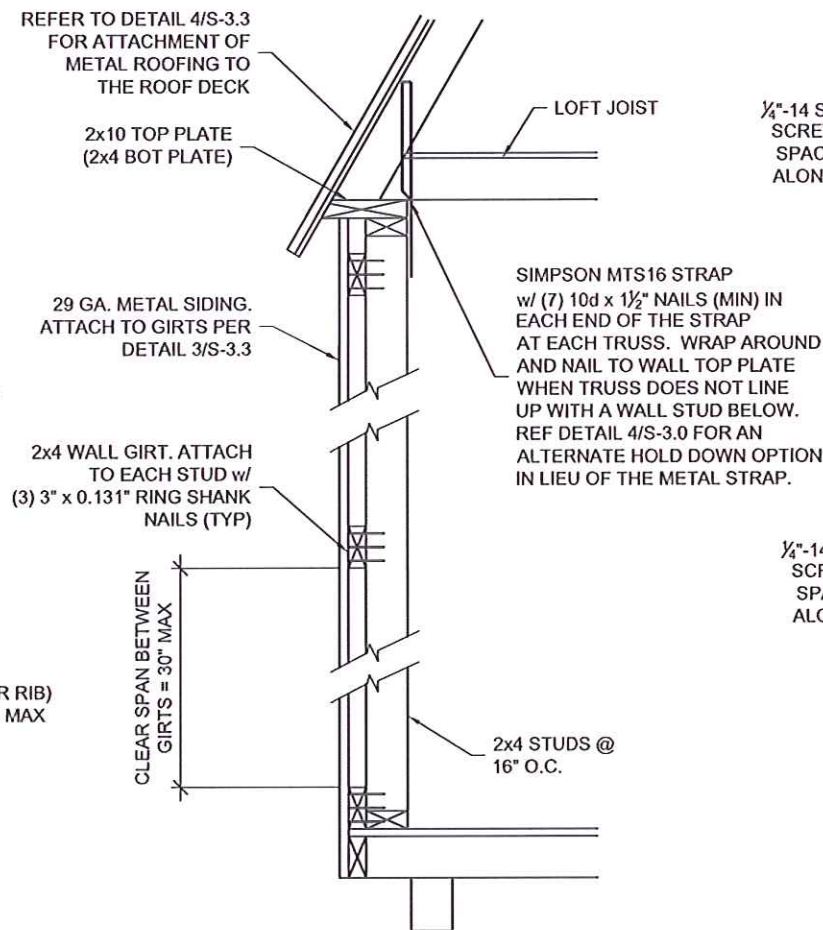NOTE: REFER TO DETAILS 1/S3.0 AND 3/S3.0 FOR INFO NOT SHOWN.

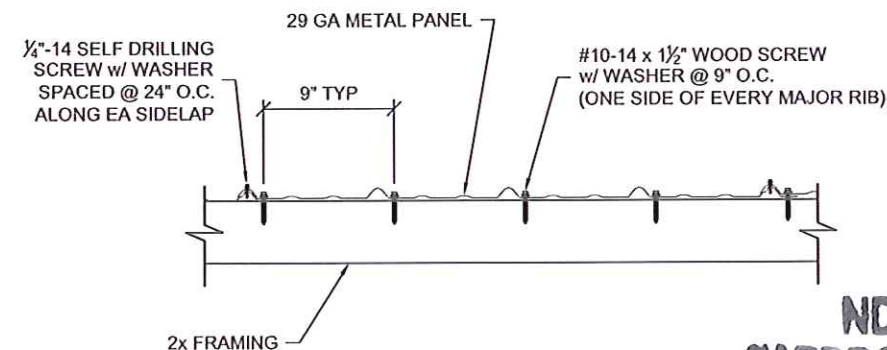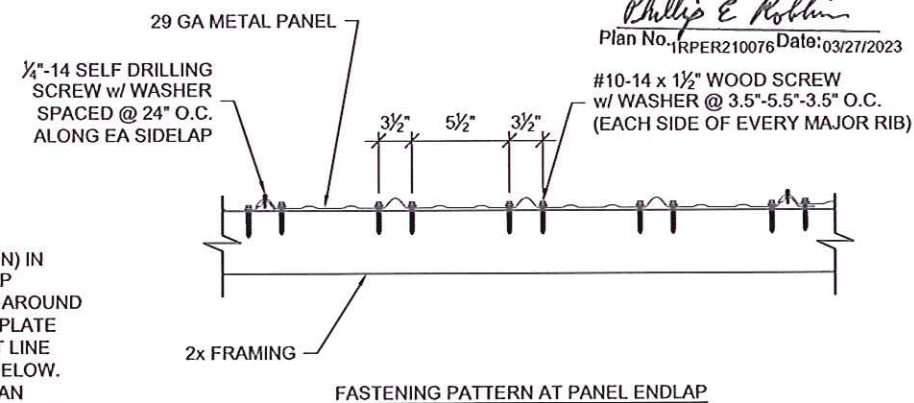

SCALE = $1\frac{1}{2}" = 1'-0"$

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NOTE: REFER TO FASTENING SCHEDULE ON SHEETS S-0.1 AND S-0.2 FOR ATTACHMENT INFORMATION NOT NOTED ON THIS SHEET.

Digitally signed by Kevin Nolan
DN:
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D834EF80000196AF, cn=Kevin Nolan, c=US
Date: 2023.03.22 13:57:06 -0500'

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PORTABLE BUILDINGS

PROJECT NO:

DATE: 09-28-2021

DRAWN BY: KLN

CHECKED BY: KLN

REVISION:


SHEET NUMBER

S-3.3-LB

SCALE: 1"=1'-0

Approved by Phillip E Robbins
Florida PE-49070
Phillip E Robbins
Plan No. 1RPER210076 Date: 03/27/2023

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1-TYPICAL HORIZ METAL SIDING DETAIL

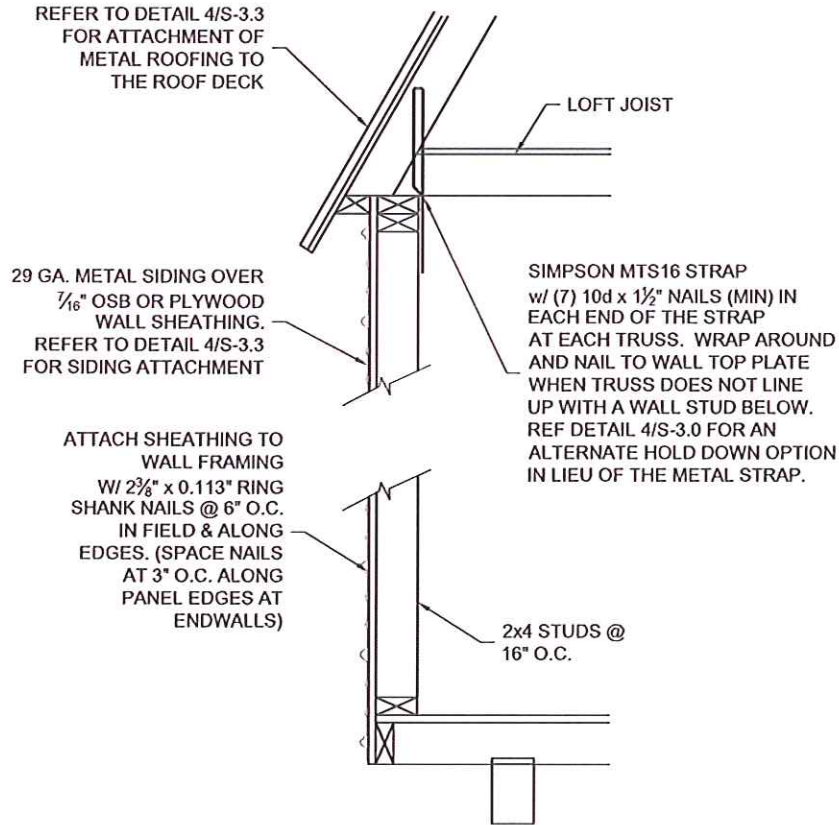NOTE: REFER TO DETAILS 1/S3.0 AND 3/S3.0 FOR INFO NOT SHOWN.



LOFTED BARN--FLORIDA--WIND=160 MPH--FBC 2020

NOTE: REFER TO FASTENING SCHEDULE ON SHEETS S-0.1 AND S-0.2 FOR ATTACHMENT INFORMATION NOT NOTED ON THIS SHEET.

Kevin L. Nolan
Digitally signed by Kevin L. Nolan
DN: 0.9.2342.19200300.100.1.1=A01410CC0000179
D834EF80000196AF, cn=Kevin L. Nolan, c=US
Date: 2023.03.22 13:55:01 -05'00'

Weather King
PORTABLE BUILDINGS

PROJECT NO:

DATE: 09-28-2021

DRAWN BY: KLN

CHECKED BY: KLN


REVISION:

SHEET NUMBER


S-34-LB

SCALE: 1"=1'-0"


1. This item has been electronically signed and sealed by Kevin L. Nolan, PE on 03/22/2023 using a digital signature.
2. Printed copies of this document are not considered signed and sealed and the signature must be verified on any electronic copy.

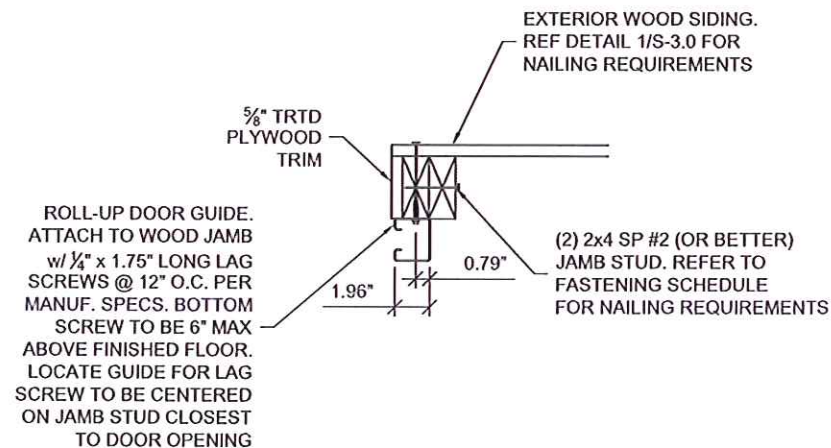

1-ROLL-UP DOOR JAMB DETAIL
(WOOD SIDING)

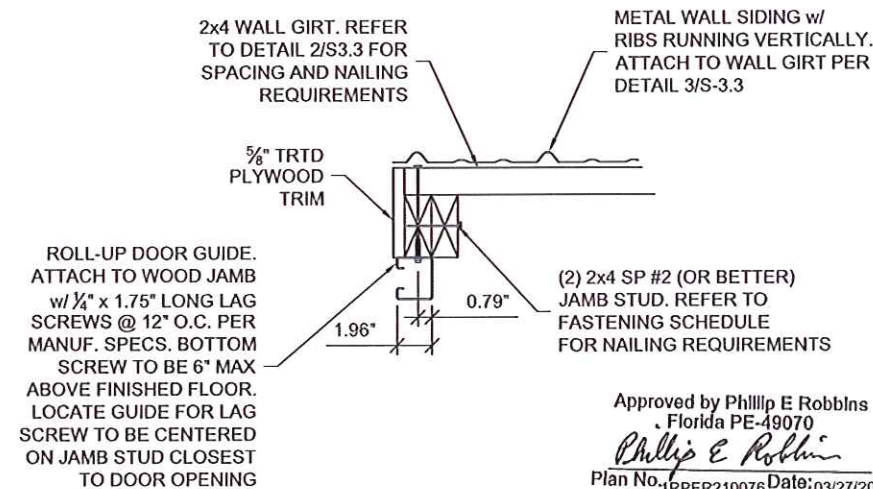


3-ROLL-UP DOOR JAMB DETAIL
(VERT METAL SIDING)

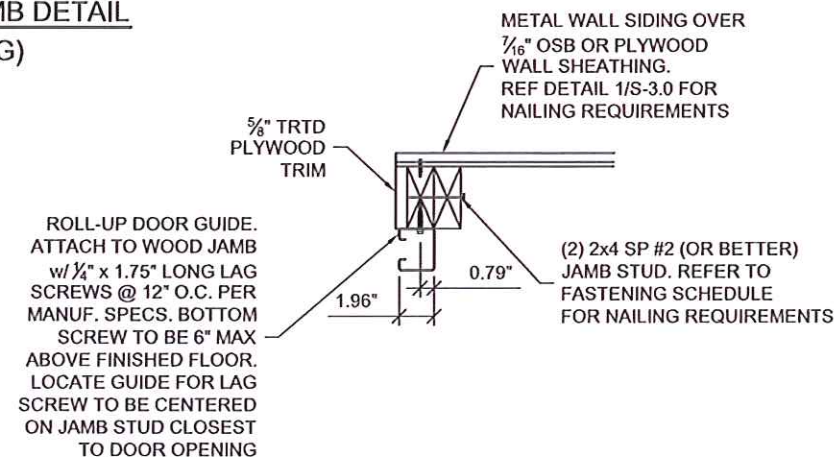

2-ROLL-UP DOOR JAMB DETAIL
(HORIZ METAL SIDING)

Approved by Phillip E Robbins
Florida PE-49070
Phillip E Robbins
Plan No. 1RPER210076 Date: 03/27/2023

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LOFTED BARN--FLORIDA--WIND=160 MPH--FBC 2020

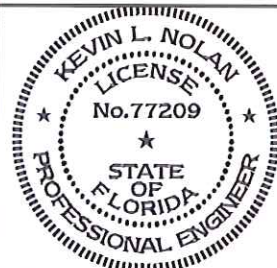NOTE: REFER TO FASTENING SCHEDULE ON SHEETS S-0.1 AND S-0.2 FOR ATTACHMENT INFORMATION NOT NOTED ON THIS SHEET.

Kevin L. Nolan


Digitally signed by Kevin L. Nolan
DN: 0.9.2342.19200300.100.1.1=A01410C0000017
9D834EF80000196AF, cn=Kevin L. Nolan, c=US
Date: 2023.03.22 13:58:47 -0500

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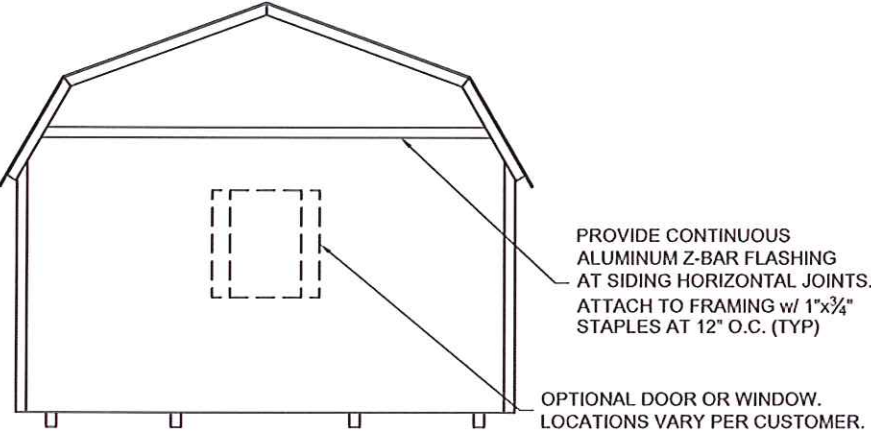
PROJECT NO:	
DATE:	09-28-2021
DRAWN BY:	KLN
CHECKED BY:	KLN
REVISION:	

SHEET NUMBER
S-3.5-LB
SCALE: 1 1/2"=1'-0


1. This item has been electronically signed and sealed by Kevin L. Nolan, PE on 03/22/2023 using a digital signature.
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FRONT ELEVATION

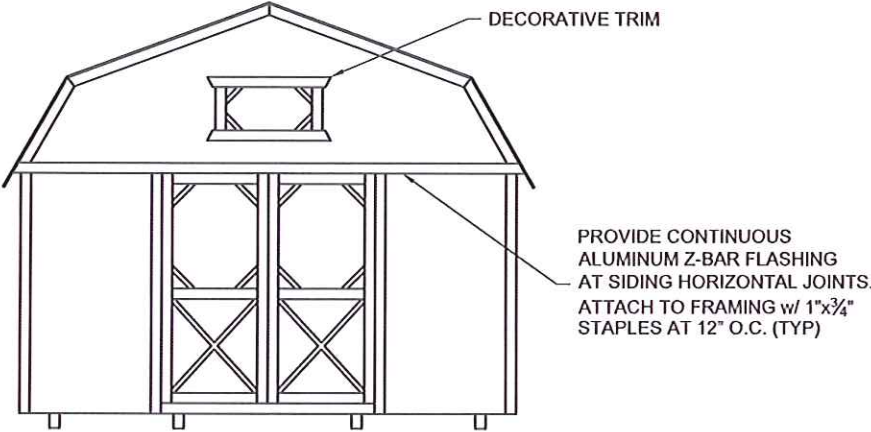

REAR ELEVATION



SIDE ELEVATION

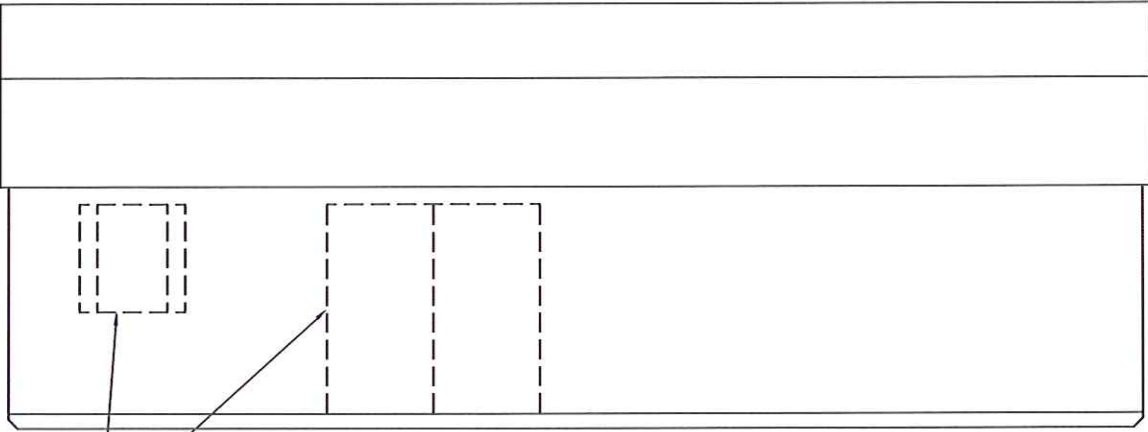Approved by Phillip E Robbins
Florida PE-49070
Phillip E Robbins
Plan No. 1RPER210076 Date: 03/27/2023

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NOTE:
WINDOWS, DOORS, AND TRIM SHOWN ARE CONCEPTUAL. ACTUAL WINDOW, DOOR, AND TRIM MAY VARY PER CUSTOMER REQUEST.



LOFTED BARN--FLORIDA--WIND=160 MPH--FBC 2020

Kevin Nolan

Digitally signed by Kevin Nolan
DN:
0.9.2342.19200300.100.1.1=A01410C00
000179D834EF80000196AF, cn=Kevin
Nolan, c=US
Date: 2023.03.22 14:00:02 -05'00'



PROJECT NO:	
DATE:	09-28-2021
DRAWN BY:	KLN
CHECKED BY:	KLN
REVISION:	

SHEET NUMBER
S-4-LB
SCALE: NOT TO SCALE

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